Design Review Sharp Rees-Stealy Otay Ranch Expansion— IS210005 Site Plan

vicinity map



project description

1400 E. PALOMAR STREET, CHULA VISTA, CA 91913

SUPPORTING THE FACILITY WILL BE SURFACE AND STRUCTURED PARKING.

FIRE SPRINKLERS: EXISTING BUILDING IS FULL SPRINKLERED. THE NEW ADDITION WILL BE FULLY SPRINKLERED.

legal description

PARCEL 3:

10.5 OF CHULA VISTA TRACT NO, 96-94A, IN THE CITY OF CHULA VISTA, COUNTY OF SAN
DIEGO, STATE OF CALIFORNIA, ACCORDING TO MAP THEREOF HO, 1999 FILED IN THE
OFFICE OF THE SAN DIEGO COUNTY FEOCOBER JULE 27, 20
SUBJECT TO THOSE RESERVATIONS AND RIGHTS CONTAINED BY THAT CERTAIN GRANT DED
RECORDED DECEMBER 9, 1999 AS FEATON, 1994-991812, OF OFFICIAL RECORDS.

PARCE, IS

EASEMENTS PAPITETEMENT TO THE LAND DESCRIBED IN PARCEL A ABOVE AS DESCRIBED IN
THE SECTIONS ENTITLED PLASMENT OF A ROCKETS AND SELF ALLEY DESCRIBETORY.

DESCRIBETORY, CONCAUTION OF A ROCKETS AND SELF ALLEY DESCRIBETORY OF THE
EAST OF A ROCKETS AND SELF ALLEY DESCRIBETORY.

AT OTAY ARMON RECORDED ON DESCRIBETS 1989, AS THE NO. 1998-09191 FOF OFFICIAL
RECORDS OF AS MOSED COUNTY, CALLEDINA, AND MY MARKEDIST OR
SUPPLEMENTA, DESCRIBETORY DESCRIBETORY OF THE MAIN STREET
OSTRICT DESCRIPTION.

PARCEL C:
TRANSPARM MEDICUSTS E MERIENTS FOR CONSTRUCTION CURPOSES AN VEHICLUR
TRANSPARM MEDICUSTS E MERIENTS FOR CONSTRUCTION CONSTRUCTION
TO MEDICAL CONSTRUCTION
TO MEDICAL

project directory

sheet index

PROJECT DIRECTORY owner/permittee			COVER
SHARP REES-STEALY	JENNIFER BUECKNER	C0 D	TITLE SHEET
8520 TECH WAY SAN DIEGO, CA 92123		C0.0	KEY MAP AND SECTIONS
858.334.8126			
		C1.0	EXISTING CONDITIONS AND PARTIAL DEMOLITION PLAN
entitlements		G2.0	GRADING PLAN
ICF 525 B STREET, SUITE 1700	LANCE UNVERZAGT ANDREW BELCOURT	C2.1	GRADING PLAN
SAN DIEGO, CA 92101	ANDIEN DESCONT	C3.0	STORM DRAIN AND UTILITIES PLAN
WORK: 858.578.8964		G3.1	STORM DRAIN AND UTILITIES PLAN
contractor		C4.0	HORIZONTAL CONTROL/SURFACE IMPROVEMENTS PLAN
DPR CONSTRUCTION	ERIC SCHEIDLINGER	C5.0	EROSION CONTROL PLAN
5010 SHOREHAM PLACE SAN DIEGO CA 92122		C5.1	EROSION CONTROL PLAN
WORK: 858.597,7070		C6.0	FIRE AND WASTE/RECYCLING TRUCK ACCESS PLAN
architect:			
ARCHITECTS hanna gabriel wells	RANDY HANNA AJA	LA100	LANDSCAPE ILLUSTRATIVE PLAN
1955 BACON STREET SAN DIEGO, CA 92107	SEAN CHEN AIA RACHEL NUCCI AIA	LS100	LANDSCAPE TREE SURVEY PLAN
WORK: 619.523.8485	THOTEL HODGI PAR	LS200	LANDSCAPE TREE SURVEY SCHEDULE AND NOTES
		LC101	LANDSCAPE CONSTRUCTION PLAN
CIVIL engineer: KETTI ER I EWECK ENGINEERING	STEVE KETTI ER	LP101	LANDSCAPE PLANTING PLAN
1620 5TH AVENUE, SUITE 675	ARMANDO URQUIDEZ		
SAN DIEGO, CA 92101 WORK 619 269 3444		A1	SITE PLAN
110101.015.205.3444		A2	FLOOR PLANS
landscape architect		A3	PARKING STRUCTURE FLOOR PLANS
GROUNDLEVEL LANDSCAPE ARCHITECTURE 2605 STATE STREET, SUITE B	IAN MORRIS AZI YNN HARE	A4	ELEVATIONS
SAN DIEGO, CA 92103	AZETNIN HARE	A5	PARKING STRUCTURE FLEVATIONS
WORK: 619.325.1990		A6	BENDERING VIEWS
electrical engineer			
TANNER ENGINEERING	VALERIE BRYNE	E100	PHOTOMETRICS AT PROPERTY LINE
5250 JACKSON DRIVE, #200			

SHARP OTAY RANCH MOB

Design Review: DR21-0029

Conditional Use Permit: CUP21-0019

Environmental Review: IS21-0005



PROPOSED

Medical Office Building (Medical, Dental & Health Services) RM2/C/CPF

SHARP Rees-Stealy Medical Centers

date description

SHARP OTAY RANCH MOB 1400 E. PALOMAR STREET CHULA VISTA, CA 91913


2022.06.27 hgw project number

ENVIRONMENTAL: IS21-0005 DESIGN REVIEW: DR21-0029 CONDITION USE: CUP21-0019

site plan

A1

CITY OF CHULA VISTA

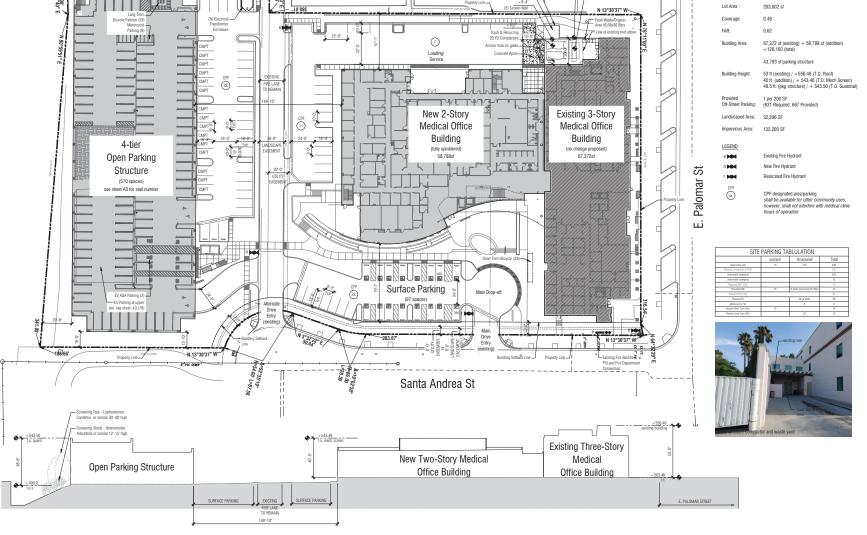

PHASE II CONSTRUCTION

N 13°30'37" W \



revision schedule

date description

SHARP OTAY RANCH MOB

1400 E. PALOMAR STREET
CHULA VISTA, CA 91913

date 2022.06.27 hgw project number 21.45

ogency project number

ENVIRONMENTAL: IS21-0005 DESIGN REVIEW: DR21-0029 CONDITION USE: CUP21-0019


PHOTOMETRICS AT PROPERTY LINE

N .

project phose

CITY OF CHULA VISTA

E100

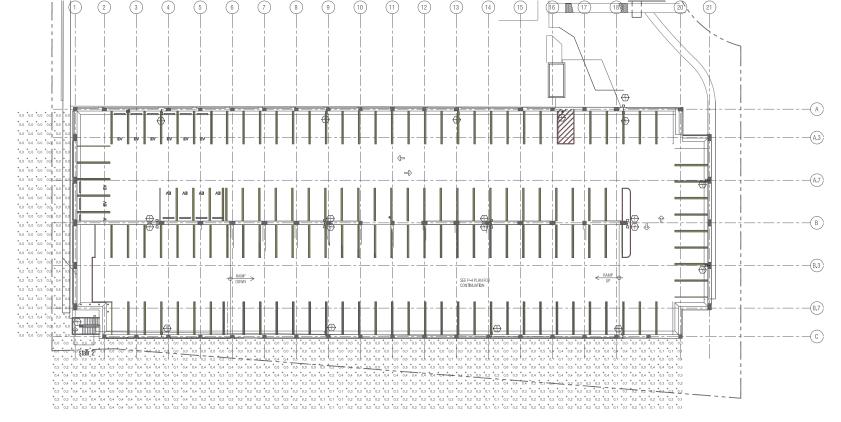

1 PHOTOMETRICS AT PROPERTY LINE

1/16" = 1'-

Design Review Sharp Rees-Stealy Otay Ranch Expansion— IS210005 Elevations

SHARP Rees-Stealy Medical Centers



revision schedule

—LINE OF EXISTING BUILDING

102097 proposed interior refuse bin


Refuse Compactor Use

Anselmo Alleva, Director of Facilities, Sharp

Currently we have 1 garbage and 1 recycle dumpster to service the existing Otay Ranch facility, both are picked up daily and are often to capacity.

By adding the additional 60,000 sq. ft., we will need to increase garbage bins to 3 and recycle to 2, while maintaining daily pick up service.

The proposed compactors (1 trash & 1 recycle) will utilize a smaller foot print than 5 dumpsters and the frequency of pick up will be "as needed" and based on experience from other SRS sites is anywhere from once every 2-3 weeks, significantly reducing traffic trips and relieving congestion in the back of the building, namely for the ambulance parking and vendor deliveries.

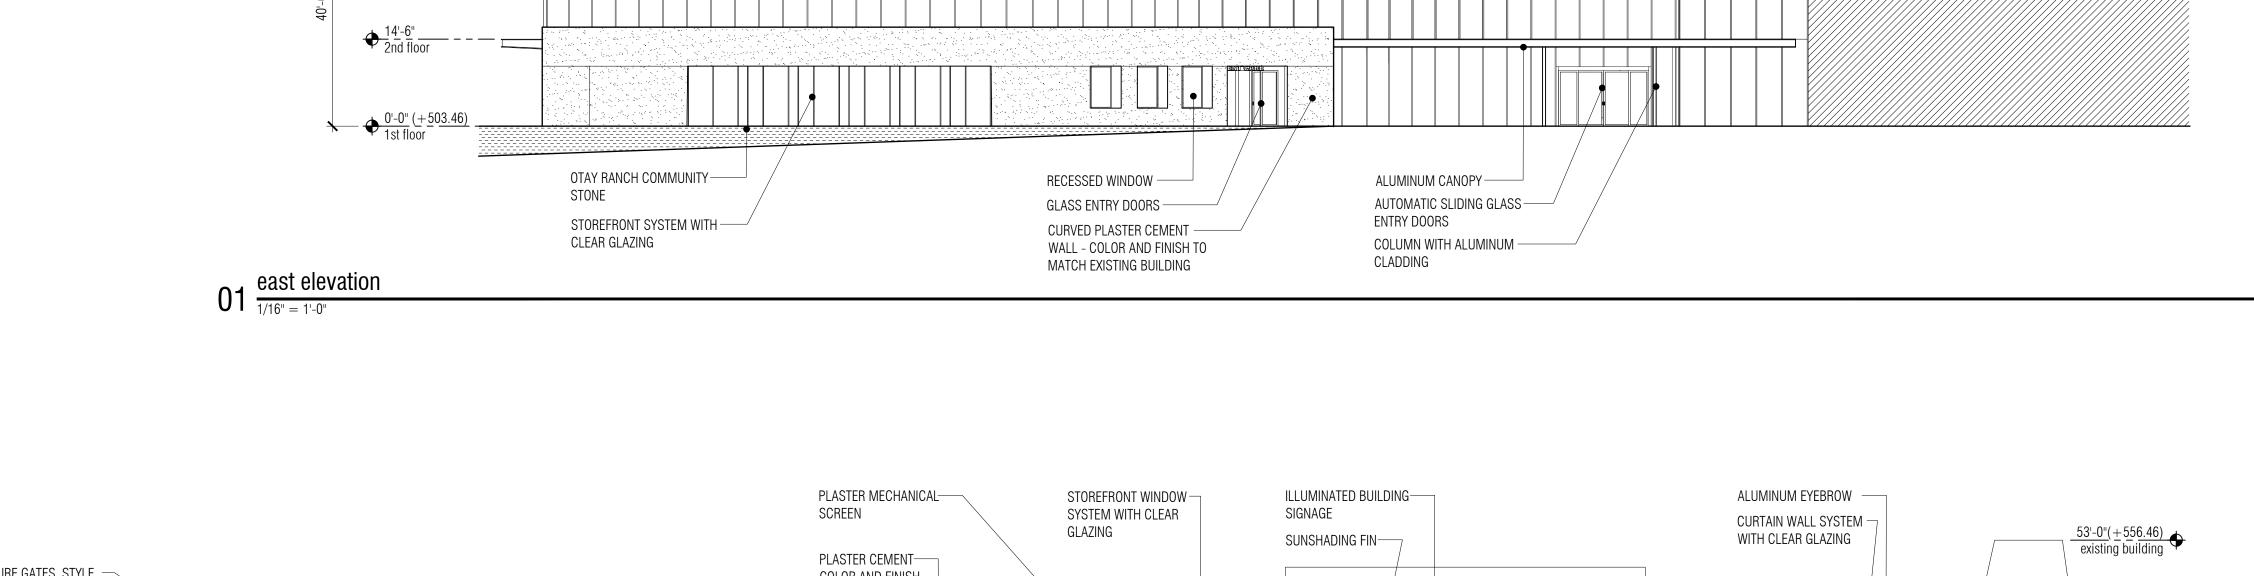

ILLUMINATED ———

BUILDING SIGNAGE

ALUMINUM EYEBROW

ALUMINUM FASCIA -

PLASTER MECHANICAL—

CURTAIN WALL SYSTEM -WITH CLEAR GLAZING

SCREEN


TRASH ENCLOSURE GATES, STYLE -COLOR AND FINISH TO MATCH ADJACENT EXISTING TO MATCH EXISTING - $\frac{40'-0''}{\text{t.o. mech. screen}} \frac{40'-0''}{\text{t.o. mech. screen}} -$ TRANSFORMER GATES LINE OF EXISTING—— BUILDING BUILDING BEYOND _____ 12' HIGH PLANTED -4x4x1/4" STEEL HSS GATE SUPPORT VERTICAL TRELLIS WITH HEAVY DUTY HINGES, PAINTED TO MATCH ADJACENT EXISTING $\frac{14'-6''}{2 \cdot 100 \cdot 100}$ CONCRETE PILE FOUNDATION FOR — GATE POST, TYPICAL 3 0'-0" (+503.46) 1st floor ALUMINUM CANOPY— TILT UP DOOR FOR— EXISTING ——/ TRANSFORMER PLASTER CEMENT— INDOOR-OUTDOOR ACCENT COLOR CONNECTION GATES CURVED PLASTER — OTAY RANCH— COMMUNITY STONE CEMENT WALL $02 \frac{\text{south elevation}}{\frac{1}{16"} = \frac{1}{-0"}}$



view of existing screen wall



view of proposed extension to existing screen wall $04 \frac{\text{screen wall rendering}}{\text{NTS}}$

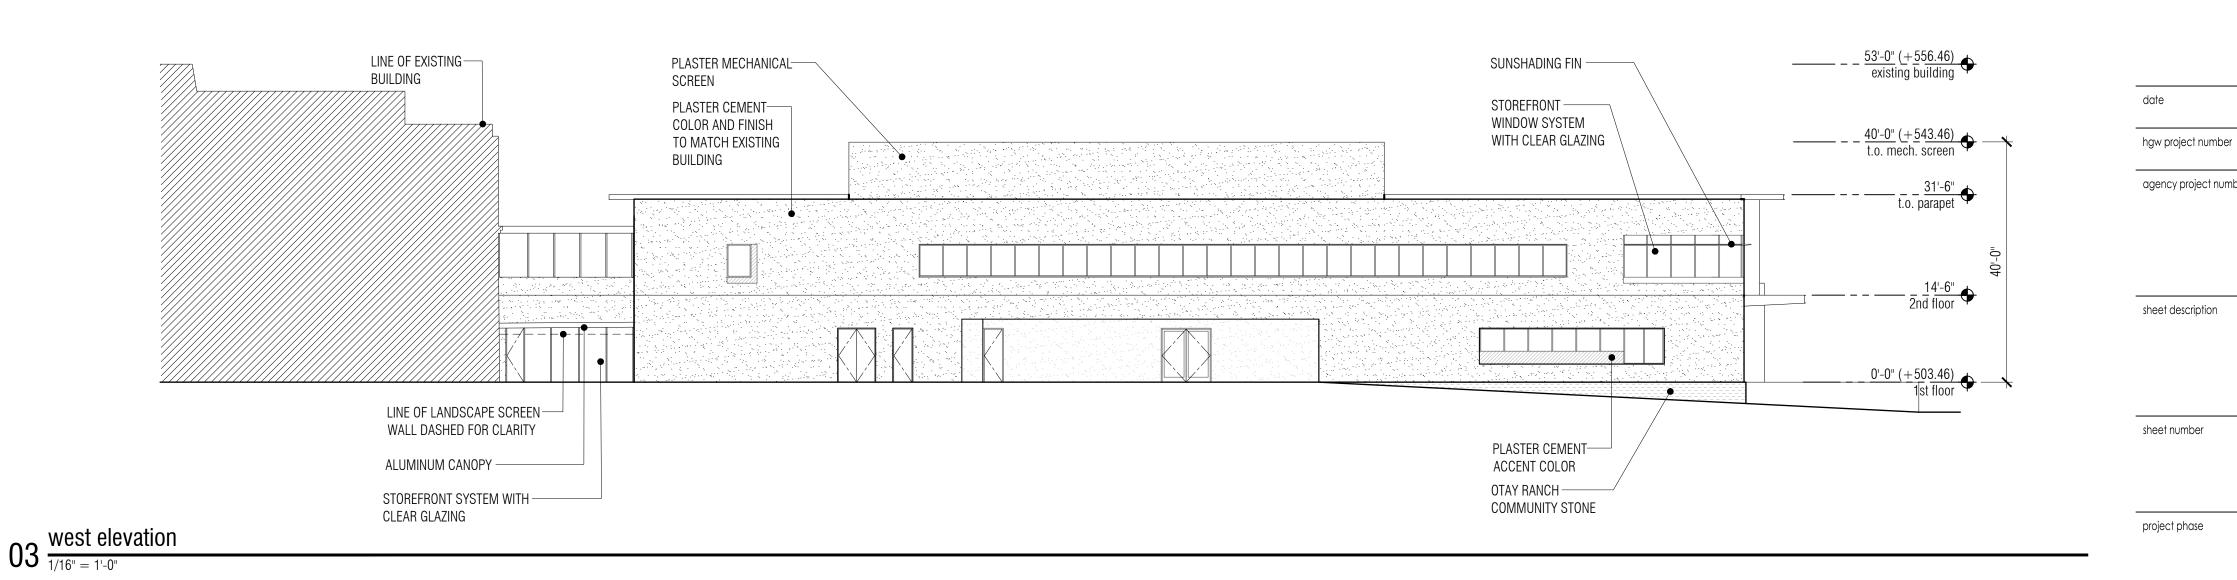

project

SHARP OTAY RANCH MOB

2022.06.27

1400 E. PALOMAR STREET CHULA VISTA, CA 91913

21.45 agency project number ENVIRONMENTAL: IS21-0005 DESIGN REVIEW: DR21-0029 CONDITION USE: CUP21-0019

sheet description

exterior elevations

A4

sheet number

project phase

1955 bacon street san diego, ca 92107 619.523.8485 619.523.8487 www.architects-hgw.com

SHARP Rees-Stealy Medical Centers






revision schedule

date

description

 $01 \frac{\text{north elevation}}{\frac{1}{16"} = \frac{1}{-0"}}$

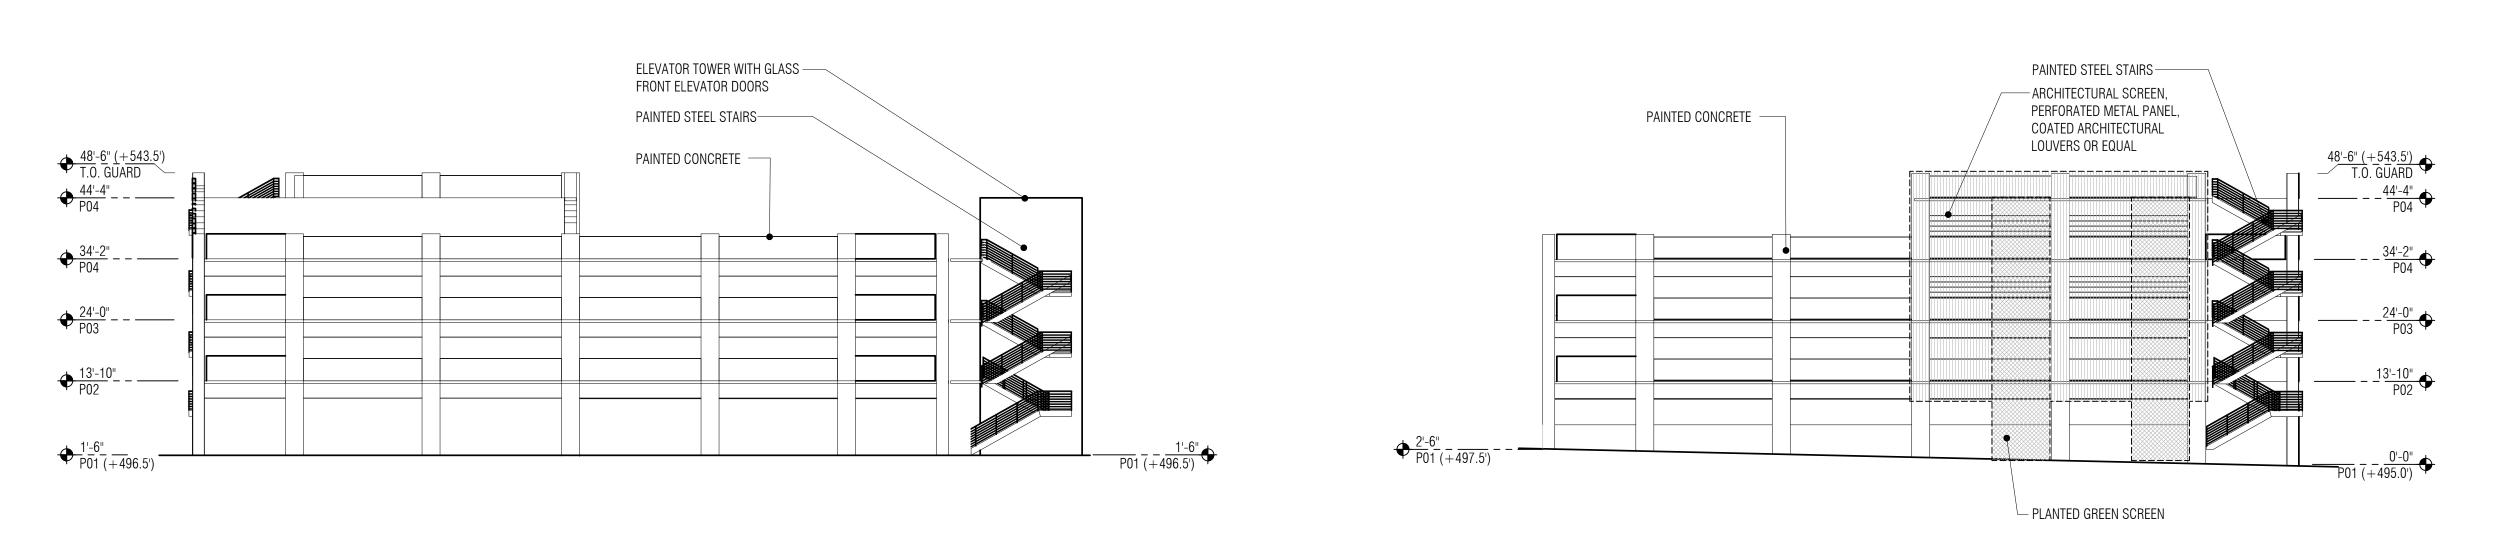

 $\frac{\text{west elevation}}{\frac{1}{16"} = \frac{1}{0}}$

 $02 \frac{\text{east elevation}}{\frac{1}{16"} = 1' - 0"}$

SHARP OTAY RANCH MOB

1400 E. PALOMAR STREET CHULA VISTA, CA 91913

hgw project number

2022.06.27

21.45

agency project number

ENVIRONMENTAL: IS21-0005 DESIGN REVIEW: DR21-0029 CONDITION USE: CUP21-0019

sheet description exterior elevations

sheet number

project phase

CITY OF CHULA VISTA

A5

PANTED STEEL STATES

ACCURRENT ALL SOREEL
PERFORMED METER PANEL
COAL PARTED GREEN SCREEN

PLANTED GREEN SCREEN SCREEN

PLANTED GREEN SCREEN SCRE


 $04 \frac{\text{south elevation}}{\frac{1}{16"} = \frac{1}{-0"}}$



revision schedule



02 view of plaza at southeast corner of mob

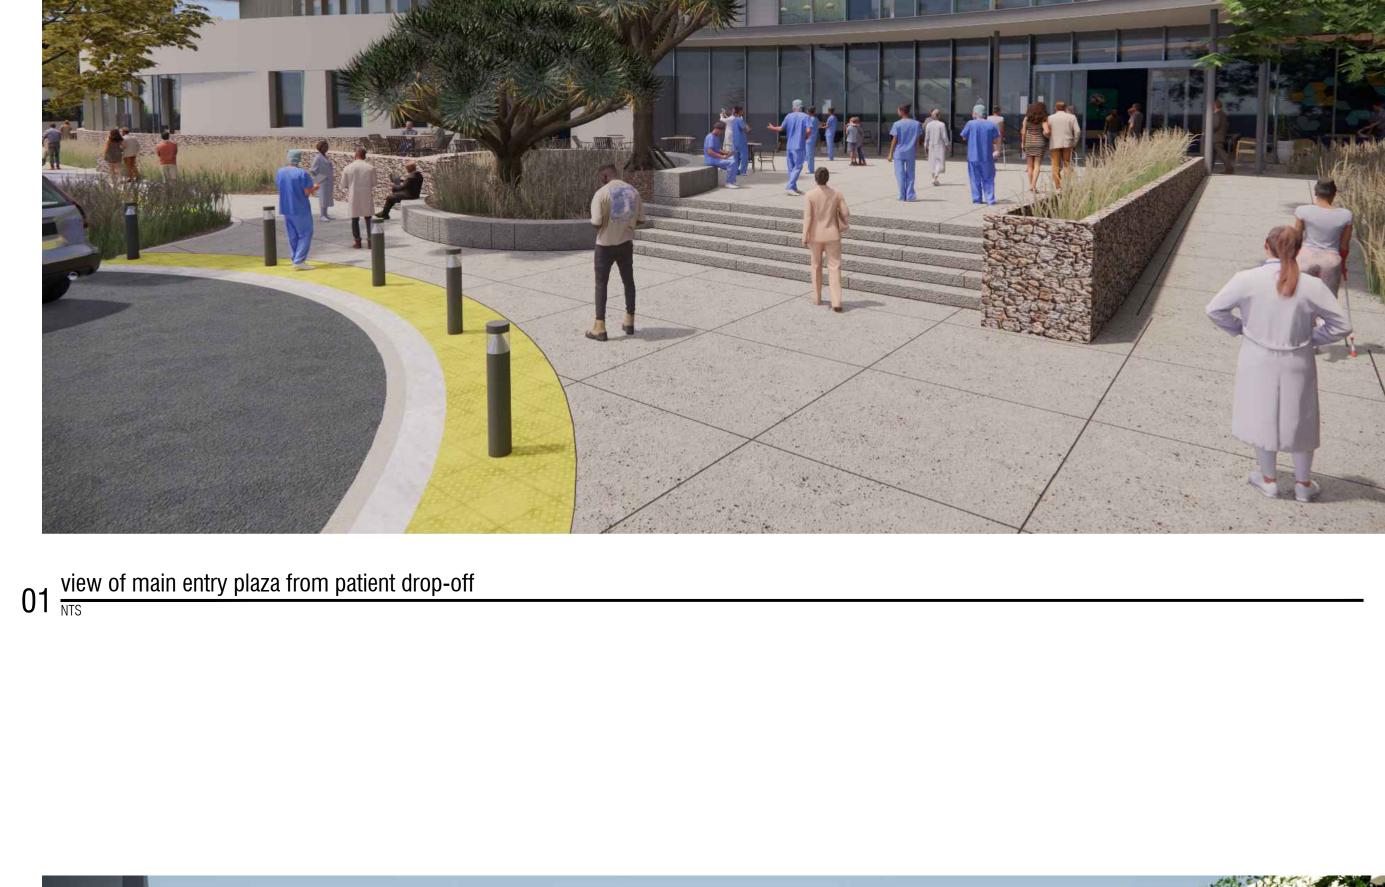



04 view of parking structure from southwest corner

sheet description rendering views

SHARP OTAY RANCH MOB

1400 E. PALOMAR STREET CHULA VISTA, CA 91913

ENVIRONMENTAL: IS21-0005 DESIGN REVIEW: DR21-0029 CONDITION USE: CUP21-0019

2022.06.27

21.45

project phase

sheet number

hgw project number

agency project number

03 view of parking structure from southeast corner

Design Review Sharp Rees-Stealy Otay Ranch Expansion— IS210005 Floor Plans

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SHARP Rees-Stealy Medical Centers



revision schedule

TRASH/ LOADING (01 A4) PICK-UP KNOX BOX — FIRST FLOOR PLAN: 3,325 SF 7,570 SF 8,300 SF RADIOLOGY: URGENT CARE: 1,530 SF CONFERENCE: LOBBY: SUPPORT: 4,480 SF 4,145 SF TOTAL: 29,710 SF

PEDIATRIC 💆

AREA

PHYSICAL

THERAPY

PHYSICAL

THERAPY

155'-0"

134'-0"

SHARP OTAY RANCH MOB 1400 E. PALOMAR STREET CHULA VISTA, CA 91913

date 2022.06.27 hgw project number 21.45

agency project number ENVIRONMENTAL: IS21-0005 DESIGN REVIEW: DR21-0029

floor plans

CONDITION USE: CUP21-0019

sheet description

sheet number

project

project phase

CITY OF CHULA VISTA

10,525 SF 9,900 SF 5,830 SF 2,550 SF

28,805 SF


SECOND FLOOR PLAN: CLINICAL SPACE:

PHYSICAL THERAPY:

SUPPORT: LAB:

<u>01</u> A4


5'-0" x 4'-6" —— FIRE CONTROL ROOM $01 \frac{\text{first floor plan}}{\frac{1}{32^{"}=1^{'}-0^{"}}}$

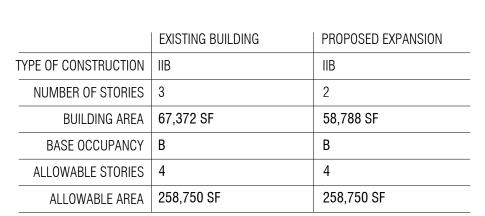

 $03 \frac{\text{roof plan}}{\frac{1}{32^{"} = 1' - 0"}}$

03 A4



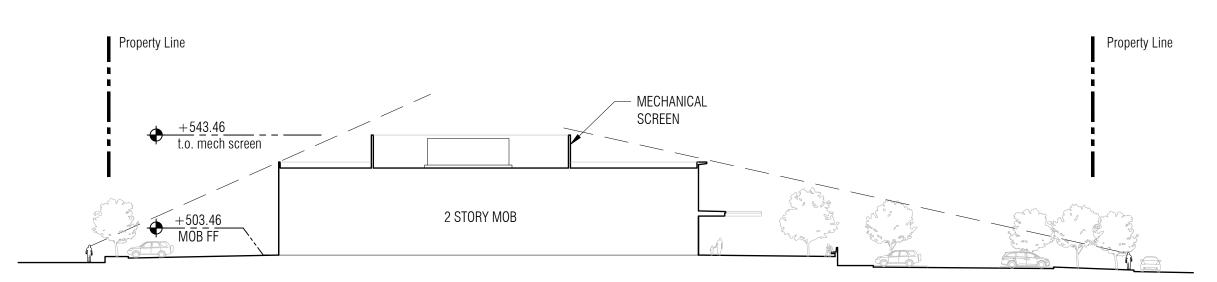

ROOF AREA BELOW 134'-0"

PROPOSED PV

PROPOSED PV

155'-0"

- LINE OF ROOF

CANOPY BELOW

- ENERGY SMART MEMBRANE

ROOFING

- MECHANICAL SCREEN

- MECHANICAL UNIT, TYP.

ROOF DRAIN AND

OVERFLOW

- ROOF HATCH

SLOPE ▼ I

 $04 \frac{\text{site section}}{\frac{1}{32''} = \frac{1}{-0''}}$

 $02 \frac{\text{second floor plan}}{\frac{1}{32^{\text{n}}} = \frac{1}{0}}$

03 A4













revision schedule

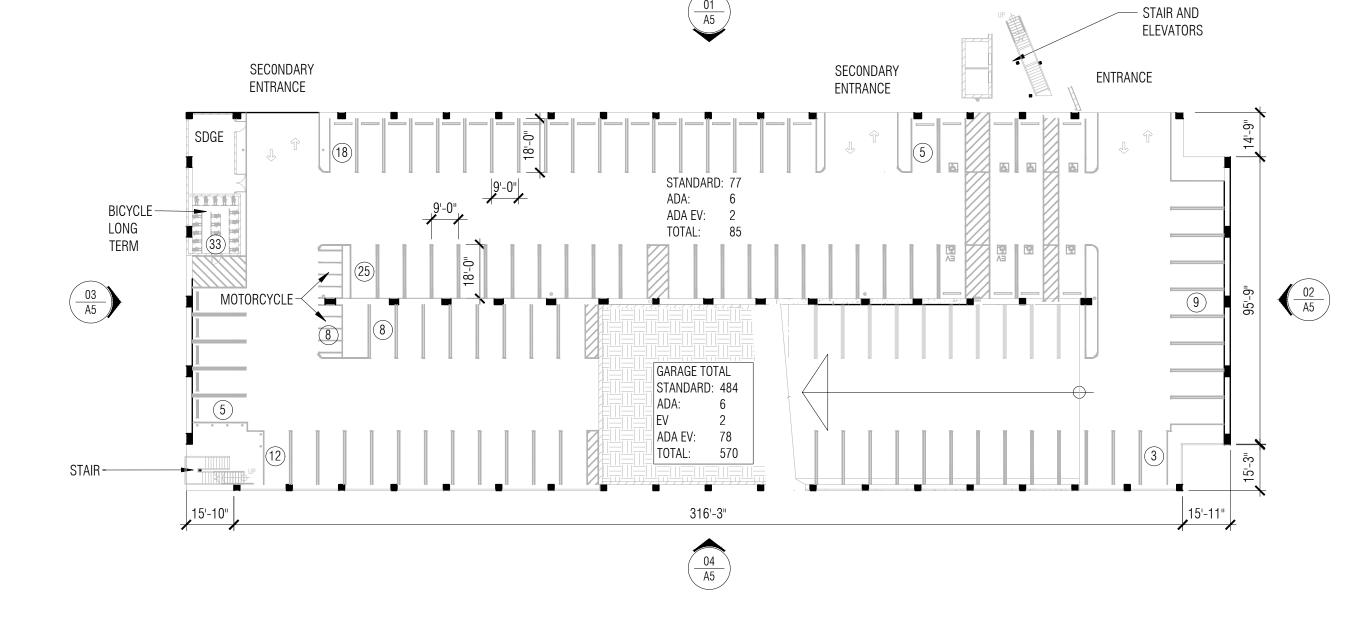

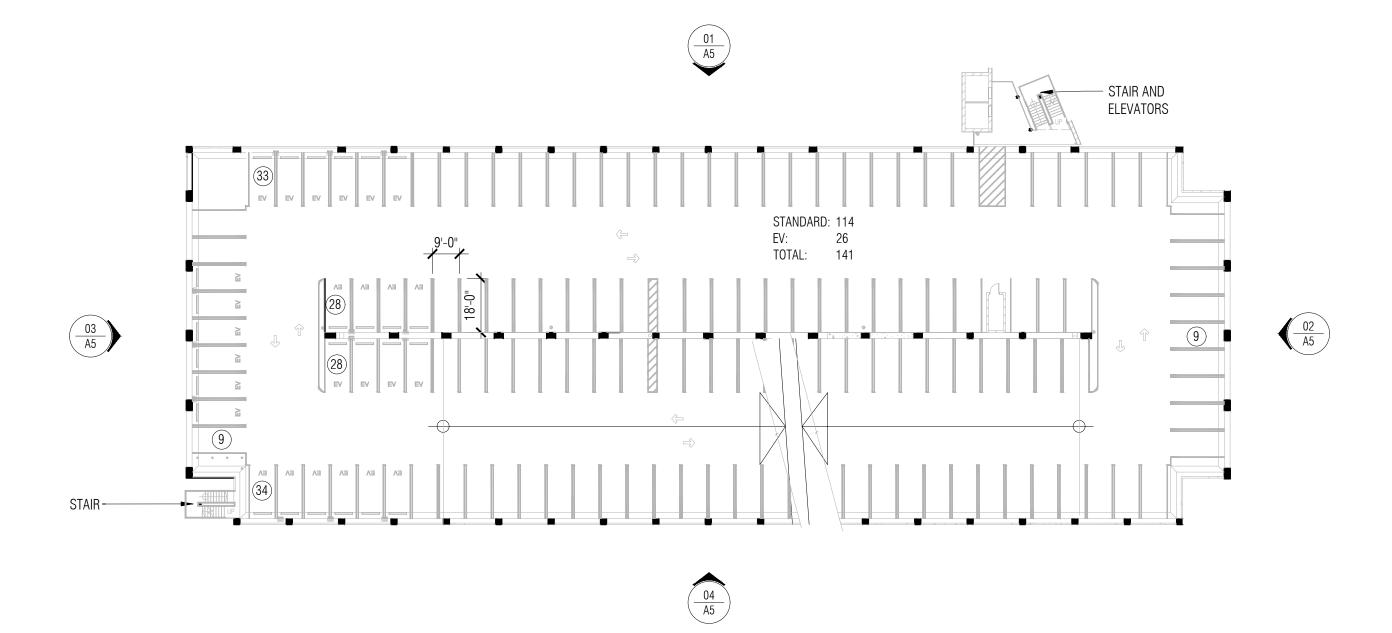



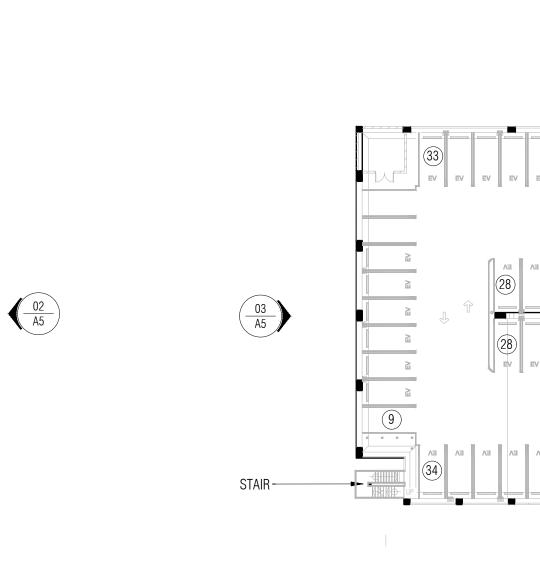

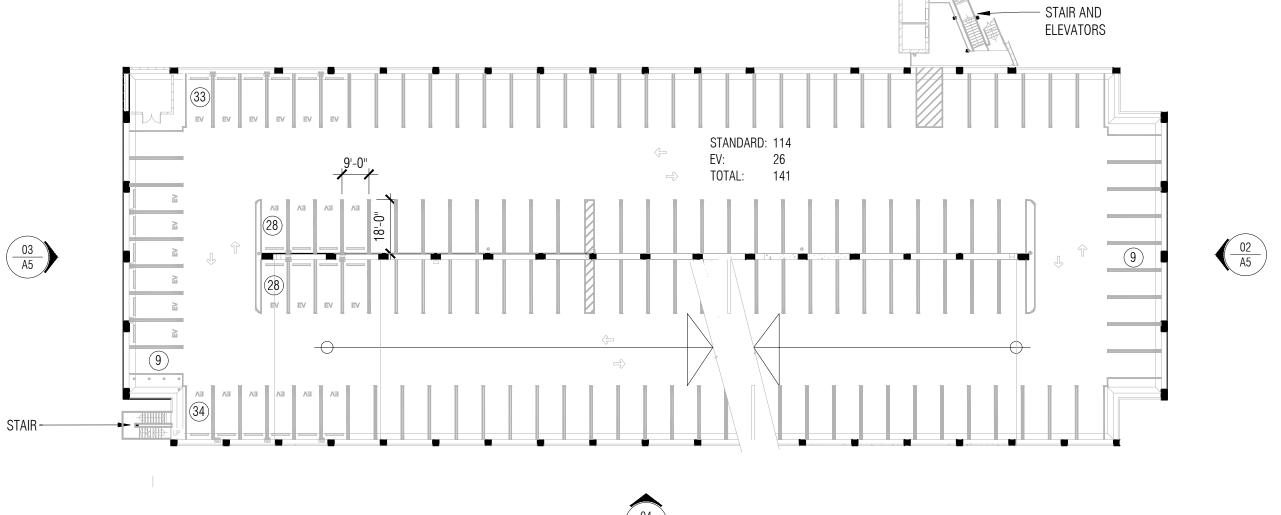



1400 E. PALOMAR STREET CHULA VISTA, CA 91913

date	2022.06.27
hgw project number	21.45
agency project number	ENVIRONMENTAL: IS21-0005 DESIGN REVIEW: DR21-0029 CONDITION USE: CUP21-0019

sheet description


parking structure plans


sheet number

project phase

CITY OF CHULA VISTA

A3

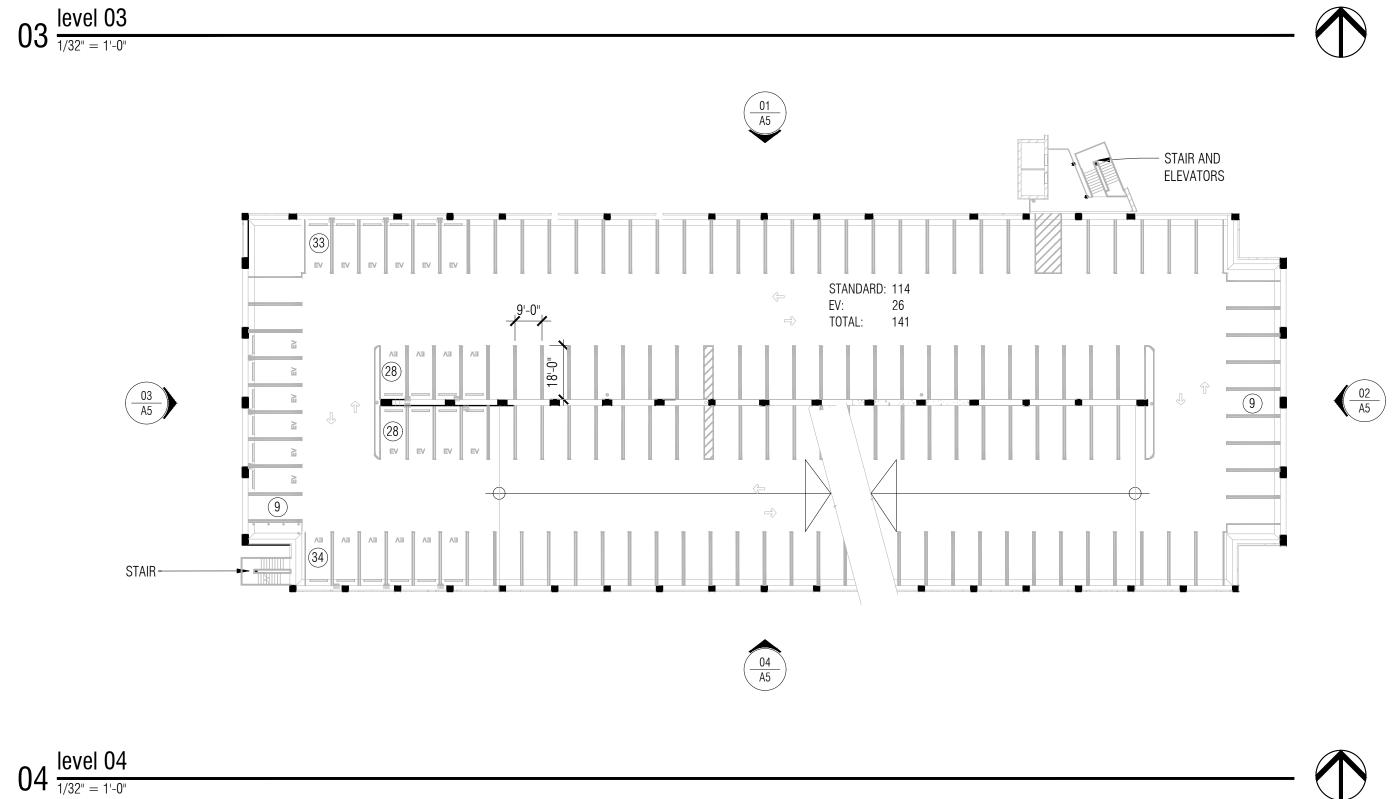

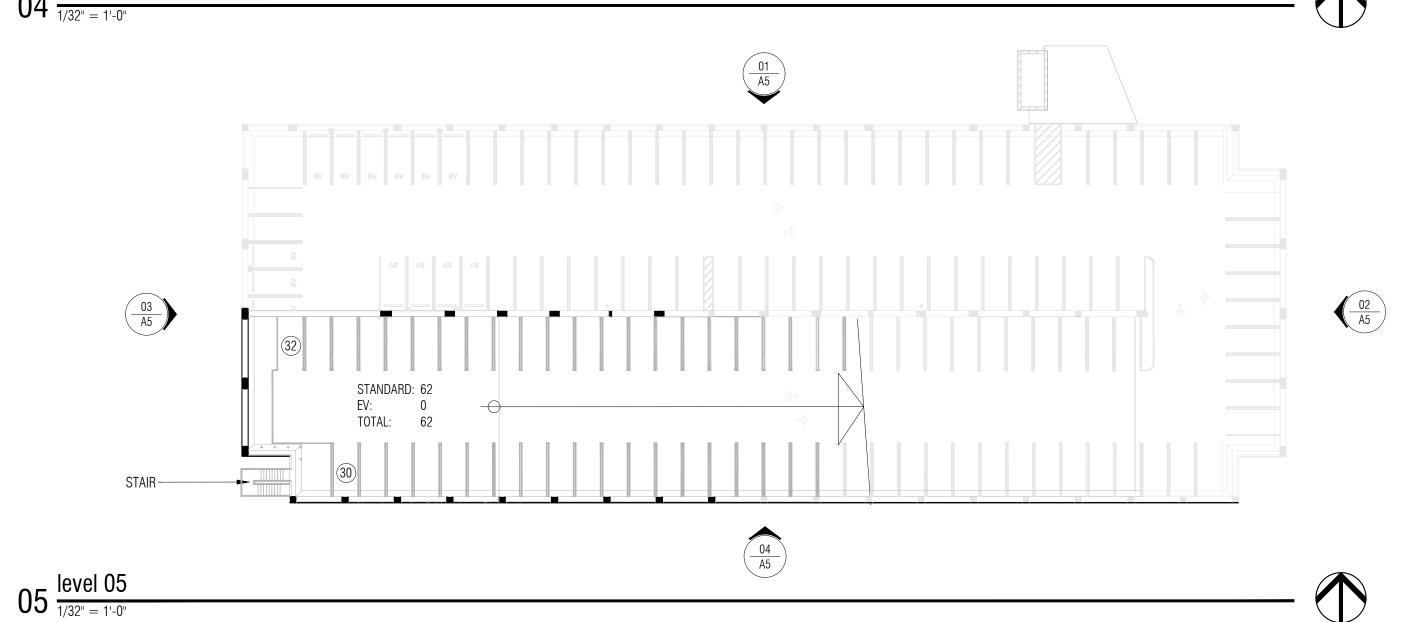

Design Review Sharp Rees-Stealy Otay Ranch Expansion— IS210005 Conceptual Landscape Plans

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revision schedule

date

descript



project

SHARP OTAY RANCH MOB

1400 E. PALOMAR STREET CHULA VISTA, CA 91913 2022.06.27

hgw project number

agency project number

ENVIRONMENTAL: IS21-0005 DESIGN REVIEW: DR21-0029 CONDITION USE: CUP21-0019

21.45


sheet description


LANDSCAPE ILLUSTRATIVE PLAN


sheet number

LA100

project phase

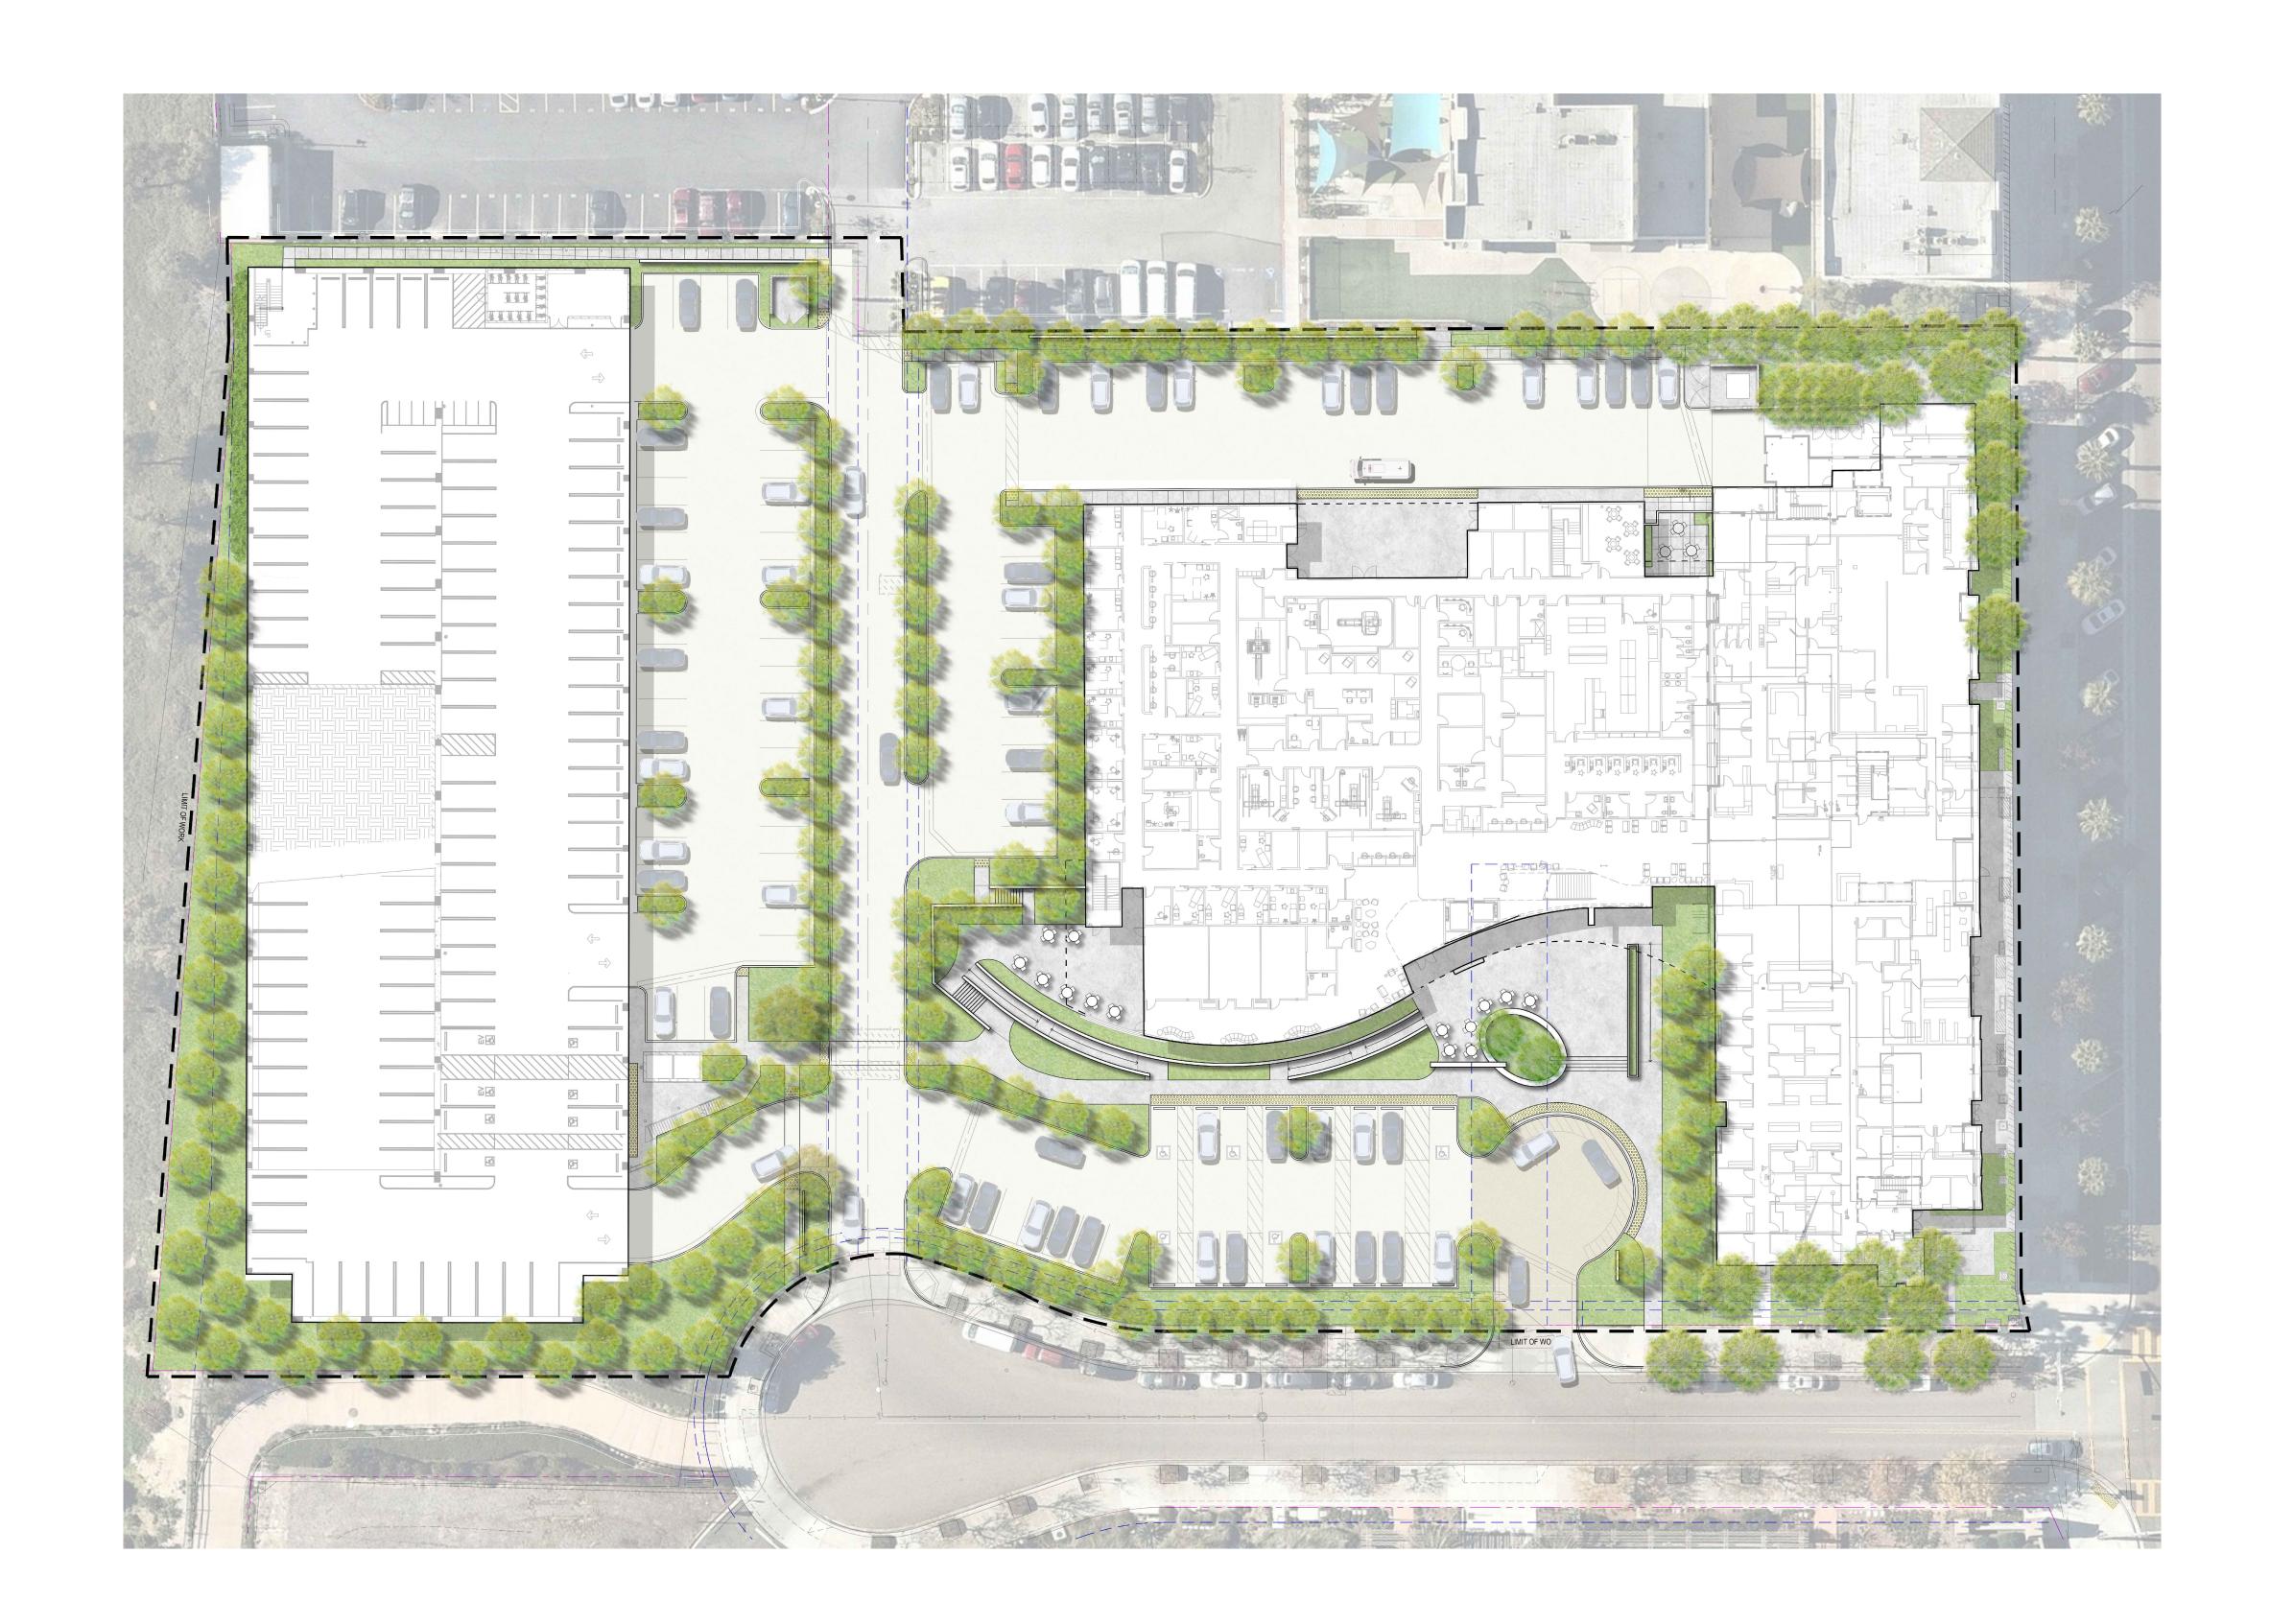

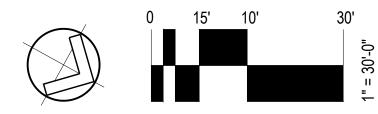

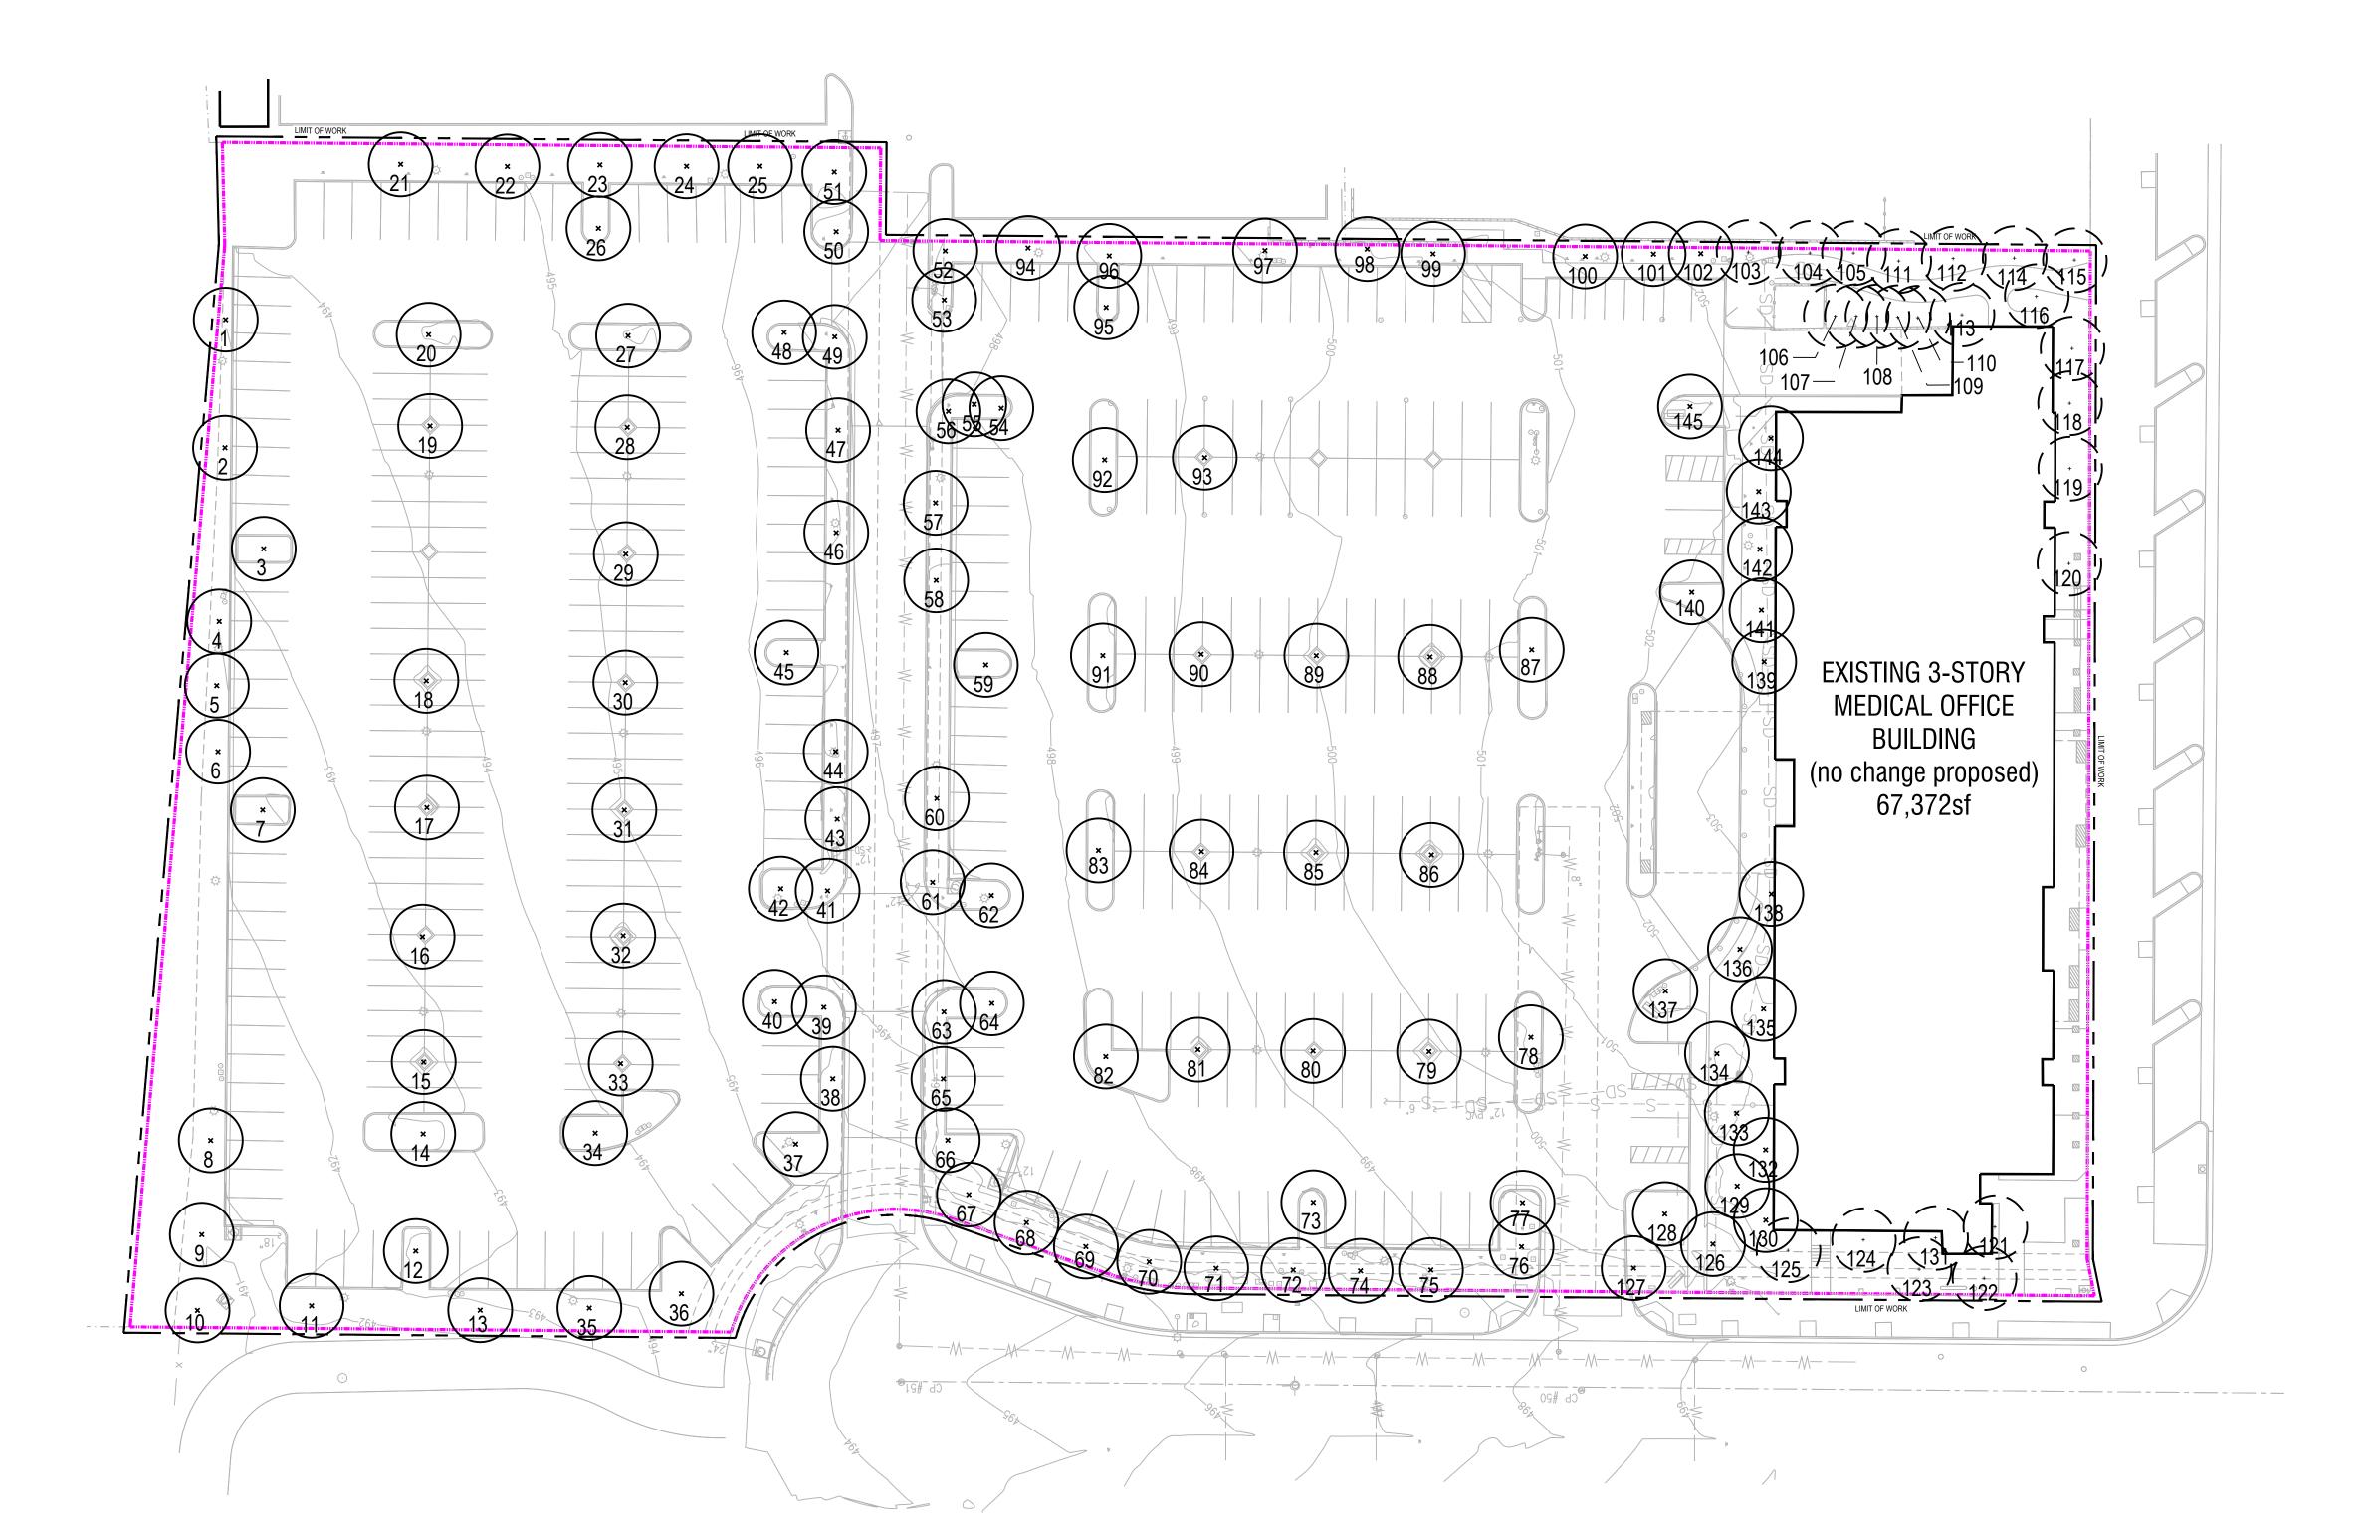

REMOVE TREE

+ PROTECT TREE

ARCHITECTS
hanna gabriel wells

1955 bacon street san diego, ca 92107 & 619.523.8485 & 619.523.8487 www.architects-hgw.com







revision schedule

no (

descripti



project

SHARP OTAY RANCH MOB

1400 E. PALOMAR STREET CHULA VISTA, CA 91913

hgw project number 21.45
agency project number

ENVIRONMENTAL: IS21-0005
DESIGN REVIEW: DR21-0029
CONDITION USE: CUP21-0019


sheet description

LANDSCAPE TREE SURVEY PLAN

sheet number

LS100

project phase

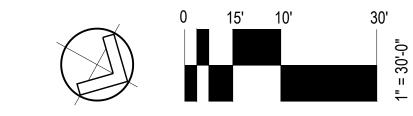

	PROTECTION & REMO		OALIDED	LIFICLIT	000540	ACTION	55	TRISTANIA CONFERTA	BRISBANE BOX	2	12'	8'	REMOVE
NUMBER	TREE SPECIES CORYMBIA	COMMON NAME	CALIPER	HEIGHT	SPREAD	ACTION	56	WASHINGTONIA	MEXICAN FAN PALM	3	20' BTH	12'	REMOVE
1	CITRIODORA	LEMON EUCALYPTUS	2	15'	-	REMOVE		ROBUSTA					
2	TRISTANIA CONFERTA	BRISBANE BOX	2	12'	8'	REMOVE	57	TRISTANIA CONFERTA	BRISBANE BOX	3	12'	8'	REMOVE
3	TRISTANIA CONFERTA	BRISBANE BOX	2	12'	8'	REMOVE	58	TRISTANIA CONFERTA	BRISBANE BOX	1	6'	8'	REMOVE
4	TRISTANIA CONFERTA	BRISBANE BOX	2	12'	8'	REMOVE	59	TRISTANIA CONFERTA	BRISBANE BOX	2	12'	8'	REMOVE
5	TRISTANIA CONFERTA	BRISBANE BOX	2	12'	8'	REMOVE	60	TRISTANIA CONFERTA	BRISBANE BOX	2	12'	8'	REMOVE
6	TRISTANIA CONFERTA	BRISBANE BOX	2	12'	8'	REMOVE	61	WASHINGTONIA ROBUSTA	MEXICAN FAN PALM	3	20' BTH	12'	REMOVE
7	TRISTANIA CONFERTA	BRISBANE BOX	2	12'	8'	REMOVE	62	WASHINGTONIA ROBUSTA	MEXICAN FAN PALM	3	20' BTH	12'	REMOVE
8	TRISTANIA CONFERTA	BRISBANE BOX	2	18'	8'	REMOVE	63	WASHINGTONIA ROBUSTA	MEXICAN FAN PALM	3	20' BTH	12'	REMOVE
9	TRISTANIA CONFERTA	BRISBANE BOX	2	18'	8'	REMOVE	64	WASHINGTONIA ROBUSTA	MEXICAN FAN PALM	3	20' BTH	12'	REMOVE
				18'	8'		65	TRISTANIA CONFERTA	BRISBANE BOX	2	15'	8'	REMOVE
10	TRISTANIA CONFERTA		2			REMOVE	66	TRISTANIA CONFERTA	BRISBANE BOX	2	15'	8'	REMOVE
11	TRISTANIA CONFERTA	BRISBANE BOX	2	18'	8'	REMOVE							
12	TRISTANIA CONFERTA	BRISBANE BOX	2	15'	8'	REMOVE	67	PISTACIA CHINESIS	CHINESE PISTACHE	1	10'	8'	REMOVE
13	TRISTANIA CONFERTA	BRISBANE BOX	1	6'	8'	REMOVE	68	PISTACIA CHINESIS	CHINESE PISTACHE	1	10'	8'	REMOVE
14	TRISTANIA CONFERTA	BRISBANE BOX	1	8'	8'	REMOVE	69	PISTACIA CHINESIS	CHINESE PISTACHE	1	10'	8'	REMOVE
15	TRISTANIA CONFERTA	BRISBANE BOX	1	8'	8'	REMOVE	70	PISTACIA CHINESIS	CHINESE PISTACHE	1	10'	8'	REMOVE
16	TRISTANIA CONFERTA	BRISBANE BOX	1	8'	8'	REMOVE	71	PISTACIA CHINESIS	CHINESE PISTACHE	1	10'	8'	REMOVE
17	TRISTANIA CONFERTA	BRISBANE BOX	2	12'	8'	REMOVE	72	PISTACIA CHINESIS	CHINESE PISTACHE	1	10'	8'	REMOVE
18	TRISTANIA CONFERTA	BRISBANE BOX	2	12'	8'	REMOVE	73	TRISTANIA CONFERTA	BRISBANE BOX	2	18'	8'	REMOVE
19	TRISTANIA CONFERTA		2	12'	8'	REMOVE	74	PISTACIA CHINESIS	CHINESE PISTACHE	1	10'	8'	REMOVE
							75	PISTACIA CHINESIS	CHINESE PISTACHE	1	10'	8'	REMOVE
20	TRISTANIA CONFERTA		2	15'	12'	REMOVE		SYAGRUS	QUEEN PALM		20' BTH	12'	REMOVE
21	TRISTANIA CONFERTA	BRISBANE BOX	2	15'	8'	REMOVE	76	ROMANZOFFIANA SYAGRUS		2			
22	TRISTANIA CONFERTA	BRISBANE BOX	2	15'	8'	REMOVE	77	ROMANZOFFIANA	QUEEN PALM	2	20' BTH	12'	REMOVE
23	TRISTANIA CONFERTA	BRISBANE BOX	2	18'	8'	REMOVE	78	TRISTANIA CONFERTA	BRISBANE BOX	2	18'	8'	REMOVE
24	TRISTANIA CONFERTA	BRISBANE BOX	2	12'	8'	REMOVE	79	TRISTANIA CONFERTA	BRISBANE BOX	1	10'	8'	REMOVE
25	TRISTANIA CONFERTA	BRISBANE BOX	1	8'	8'	REMOVE	80	TRISTANIA CONFERTA	BRISBANE BOX	1	10'	8'	REMOVE
26	TRISTANIA CONFERTA	BRISBANE BOX	2	15'	8'	REMOVE	81	TRISTANIA CONFERTA	BRISBANE BOX	1	8'	8'	REMOVE
27	TRISTANIA CONFERTA	BRISBANE BOX	2	15'	8'	REMOVE	82	TRISTANIA CONFERTA	BRISBANE BOX	2	18'	8'	REMOVE
28	TRISTANIA CONFERTA	BRISBANE BOX	2	15'	8'	REMOVE	83	TRISTANIA CONFERTA	BRISBANE BOX	1	8'	8'	REMOVE
29	TRISTANIA CONFERTA	BRISBANE BOX	2	12'	8'	REMOVE	84	TRISTANIA CONFERTA	BRISBANE BOX	1	8'	8'	REMOVE
30	TRISTANIA CONFERTA		2	12'	8'	REMOVE	85	TRISTANIA CONFERTA	BRISBANE BOX	1	8'	8'	REMOVE
							86	TRISTANIA CONFERTA	BRISBANE BOX	1	8'	8'	REMOVE
31	TRISTANIA CONFERTA		1	8'	8'	REMOVE							
32	TRISTANIA CONFERTA	BRISBANE BOX	1	10'	8'	REMOVE	87	TRISTANIA CONFERTA	BRISBANE BOX	2	12'	8'	REMOVE
33	TRISTANIA CONFERTA	BRISBANE BOX	2	12'	8'	REMOVE	88	TRISTANIA CONFERTA	BRISBANE BOX	2	12'	8'	REMOVE
34	TRISTANIA CONFERTA	BRISBANE BOX	2	12'	8'	REMOVE	89	TRISTANIA CONFERTA	BRISBANE BOX	2	12'	8'	REMOVE
35	TRISTANIA CONFERTA	BRISBANE BOX	2	20'	8'	REMOVE	90	TRISTANIA CONFERTA	BRISBANE BOX	2	12'	8'	REMOVE
36	TRISTANIA CONFERTA	BRISBANE BOX	2	20'	8'	REMOVE	91	TRISTANIA CONFERTA	BRISBANE BOX	2	12'	8'	REMOVE
37	TRISTANIA CONFERTA	BRISBANE BOX	2	15'	8'	REMOVE	92	TRISTANIA CONFERTA	BRISBANE BOX	2	12'	8'	REMOVE
38	TRISTANIA CONFERTA	BRISBANE BOX	2	15'	8'	REMOVE	93	TRISTANIA CONFERTA	BRISBANE BOX	2	12'	8'	REMOVE
39	WASHINGTONIA	MEXICAN FAN PALM	3	20' BTH	10'	REMOVE	94	TRISTANIA CONFERTA	BRISBANE BOX	1	6'	8'	REMOVE
40	ROBUSTA WASHINGTONIA	MEXICAN FAN PALM	3	20' BTH	10'	REMOVE	95	TRISTANIA CONFERTA	BRISBANE BOX	2	12'	8'	REMOVE
	ROBUSTA WASHINGTONIA						96	TRISTANIA CONFERTA	BRISBANE BOX	2	12'	8'	REMOVE
41	ROBUSTA WASHINGTONIA	MEXICAN FAN PALM	3	20' BTH	10'	REMOVE	97					8'	
42	ROBUSTA	MEXICAN FAN PALM	3	20' BTH	10'	REMOVE		TRISTANIA CONFERTA	BRISBANE BOX	2	12'		REMOVE
43	TRISTANIA CONFERTA	BRISBANE BOX	2	12'	8'	REMOVE	98	TRISTANIA CONFERTA	BRISBANE BOX	2	12'	8'	REMOVE
44	TRISTANIA CONFERTA	BRISBANE BOX	2	12'	8'	REMOVE	99	TRISTANIA CONFERTA	BRISBANE BOX	2	12'	8'	REMOVE
45	TRISTANIA CONFERTA	BRISBANE BOX	1	10'	8'	REMOVE	100	WASHINGTONIA ROBUSTA	MEXICAN FAN PALM	3	25' BTH	10'	REMOVE
46	TRISTANIA CONFERTA	BRISBANE BOX	2	15'	8'	REMOVE	101	WASHINGTONIA ROBUSTA	MEXICAN FAN PALM	3	25' BTH	10'	REMOVE
47	TRISTANIA CONFERTA	BRISBANE BOX	2	12'	8'	REMOVE	102	JACARANDA MIMOSIFOLIA	BLUE JACARANDA	1	8'	12'	REMOVE
48	WASHINGTONIA	MEXICAN FAN PALM	3	20' BTH	12'	REMOVE	103	WASHINGTONIA	MEXICAN FAN PALM	3	25' BTH	10'	PROTECT
49	ROBUSTA WASHINGTONIA	MEXICAN FAN PALM	3	20' BTH	12'	REMOVE	104	ROBUSTA WASHINGTONIA	MEXICAN FAN PALM	3	25' BTH	10'	PROTECT
	ROBUSTA WASHINGTONIA							ROBUSTA JACARANDA					
50	ROBUSTA WASHINGTONIA	MEXICAN FAN PALM	3	20' BTH	12'	REMOVE	105	MIMOSIFOLIA CUPRESSUS	BLUE JACARANDA	2	15'	12'	PROTECT
51	ROBUSTA	MEXICAN FAN PALM	3	20' BTH	12'	REMOVE	106	SEMPERVIRENS	ITALIAN CYPRESS	3	25'	5'	PROTECT
52	WASHINGTONIA ROBUSTA	MEXICAN FAN PALM	3	20' BTH	12'	REMOVE	107	CUPRESSUS SEMPERVIRENS	ITALIAN CYPRESS	3	25'	5'	PROTECT
53	WASHINGTONIA ROBUSTA	MEXICAN FAN PALM	3	20' BTH	12'	REMOVE	108	CUPRESSUS SEMPERVIRENS	ITALIAN CYPRESS	3	25'	5'	PROTECT
54	WASHINGTONIA ROBUSTA	MEXICAN FAN PALM	3	20' BTH	12'	REMOVE	109	CUPRESSUS SEMPERVIRENS	ITALIAN CYPRESS	3	25'	5'	PROTECT

CUPRESSUS SEMPERVIRENS	ITALIAN CYPRESS	3	25'	5'	PROTECT	TREE SURVEY - TOTAL SITE QUANTITY		
JACARANDA MIMOSIFOLIA	BLUE JACARANDA	2	15'	12'	PROTECT	ACTION		
JACARANDA	BLUE JACARANDA	2	15'	12'	PROTECT	PROTECT IN PLACE TREE TOTAL		
MIMOSIFOLIA							REMOVE TREE TOTAL	
WASHINGTONIA ROBUSTA	MEXICAN FAN PALM	3	30' BTH	12'	PROTECT	EXISTING TREE TOTAL		
WASHINGTONIA ROBUSTA	MEXICAN FAN PALM	3	30' BTH	12'	PROTECT	PROPOSED ADDITIONAL TREE TOTAL		
WASHINGTONIA ROBUSTA	MEXICAN FAN PALM	3	30' BTH	12'	PROTECT			
JACARANDA MIMOSIFOLIA	BLUE JACARANDA	2	15'	12'	PROTECT	TREE SURVEY NOTES		
WASHINGTONIA ROBUSTA	MEXICAN FAN PALM	3	30' BTH	12'	PROTECT	1. FOR PROPOSED TREES PLEASE REFER TO SHEET LP101		

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WASHINGTONIA

ROBUSTA

WASHINGTONIA

ROBUSTA JACARANDA

MIMOSIFOLIA

WASHINGTONIA

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MIMOSIFOLIA JACARANDA

MIMOSIFOLIA SYAGRUS

ROMANZOFFIANA SYAGRUS

ROMANZOFFIANA

PHOENIX CANARIENSIS | CANARY DATE PALM

PHOENIX CANARIENSIS | CANARY DATE PALM

MEXICAN FAN PALM

MEXICAN FAN PALM

BLUE JACARANDA

MEXICAN FAN PALM

QUEEN PALM

QUEEN PALM

QUEEN PALM

BLUE JACARANDA

BIRD OF PARADISE

BIRD OF PARADISE

BIRD OF PARADISE

BLUE JACARANDA

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BLUE JACARANDA

BIRD OF PARADISE

QUEEN PALM

QUEEN PALM

BLUE JACARANDA

BLUE JACARANDA

QUEEN PALM

QUEEN PALM

CT	TREE SURVEY - TOTAL SITE QUANTITY	
ст	ACTION	TOTAL
	PROTECT IN PLACE TREE TOTAL	23
CT	REMOVE TREE TOTAL	122
СТ	EXISTING TREE TOTAL	145
СТ	PROPOSED ADDITIONAL TREE TOTAL	153
		•

4	EXISTING TREE TOTAL	145
I	PROPOSED ADDITIONAL TREE TOTAL	153
1		
	TREE SURVEY NOTES	

DEMOLITION NOTES

PROTECT

PROTECT

PROTECT

PROTECT

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PROTECT

PROTECT

PROTECT

REMOVE

- THE TERM "REMOVE" INCLUDES ALL WORK RELATED TO EXISTING TREES, SHRUBS, GROUNDCOVER, ORNAMENTAL METAL, WOOD & HARDSCAPE ELEMENTS. ITEMS SHALL BE VERIFIED WITH THE LANDSCAPE ARCHITECT PRIOR TO REMOVAL.
- THE TERM "TO REMAIN" INCLUDES ALL WORK NECESSARY TO PROTECT AND MAINTAIN AN ITEM IN ITS CURRENT CONDITION, INCLUDING THE HEALTH OF PLANT
- THE TERM "PROTECT" INCLUDES PROVIDING OF TEMPORARY BARRICADES, WARNING MARKERS, COVERINGS, OR OTHER TYPES OF PROTECTION NECESSARY TO PREVENT DAMAGE TO EXISTING IMPROVEMENTS OR PLANT MATERIAL.
- THE TERM "SALVAGE" INCLUDES ALL WORK RELATED TO PROPER REMOVAL. CONSOLIDATION AND INVENTORY OF PARTS, PROTECTION MATERIALS, TRANSPORTING TO STORAGE, AND CLEAN-UP.
- LIMITS OF DEMOLITION IN LANDSCAPE AREAS ARE APPROXIMATE AND ARE SHOWN FOR REFERENCE. CONTRACTOR TO DETERMINE EXTENT OF DEMOLITION APPROPRIATE FOR NEW WORK WITH LANDSCAPE ARCHITECT IN THE FIELD.
- ALL VALVE BOXES, VAULTS AND OTHER UNDERGROUND UTILITIES WITHIN THE LANDSCAPE DEMOLITION AREAS ARE TO REMAIN AND BE PROTECTED IN PLACE, UNLESS OTHERWISE NOTED.
- ALL TREES THAT ARE IDENTIFIED AS PROTECTED IN PLACE SHALL HAVE YELLOW CAUTION TAPE INSTALLED ON 24" HIGH WOODEN STAKES AT THE DRIPLINE OF THE TREE TO PROTECT THE TREE ROOTS DURING CONSTRUCTION.
- THE CONTRACTOR SHALL CUT AND CAP THE EXISTING IRRIGATION SYSTEM WHERE IRRIGATION IS SCHEDULED FOR DEMOLITION. THE CONTRACTOR SHALL ENSURE THE IRRIGATION SYSTEM MAINTAINS FUNCTION TO ALL LANDSCAPE AREAS NOT REMOVED DURING DEMOLITION. CONTRACTOR SHALL PROVIDE HAND WATERING MONDAY, WEDNESDAY AND FRIDAY TO TREES THAT ARE IDENTIFIED TO BE "PROTECTED IN PLACE" WHERE THE IRRIGATION TO THOSE TREES IS TO BE REMOVED. (AN ALTERNATE IS TO PROVIDE TEMPORARY IRRIGATION TO THOSE
- ALL EXISTING CURB LINES SHALL REMAIN; PROTECT IN PLACE, UNLESS OTHERWISE
- ALL EXISTING SITE FURNISHINGS SHALL BE SALVAGED; COORDINATE WITH OWNER FOR STORAGE OR RELOCATION.
- PROTECT ALL EXISTING SITE & BUILDING UTILITIES SUCH AS A/C UNITS & ELECTRICAL JUNCTION BOXES (MAINTAIN IN GOOD WORKING ORDER).
- THE TERM "DEMO" INCLUDES COMPLETE REMOVAL OF STRUCTURES AND ASSOCIATED WALLS, METAL WORK, CONCRETE FOOTINGS, UTILITY LINES, CURBS,
- LANDSCAPE ARCHITECT TO REVIEW ALL TREES ON SITE PRIOR TO DEMO TO DETERMINE IF ANY TREES CAN BE PROTECTED AND TRANSPLANTED ON SITE DURING

ARCHITECTS hanna gabriel wells

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revision schedule

no.

description



SHARP OTAY RANCH MOB

1400 E. PALOMAR STREET CHULA VISTA, CA 91913 2022.06.27

hgw project number

agency project number


ENVIRONMENTAL: IS21-0005 DESIGN REVIEW: DR21-0029 CONDITION USE: CUP21-0019

21.45

sheet description

LANDSCAPE TREE SURVEY SCHEDULE & NOTES

project phase

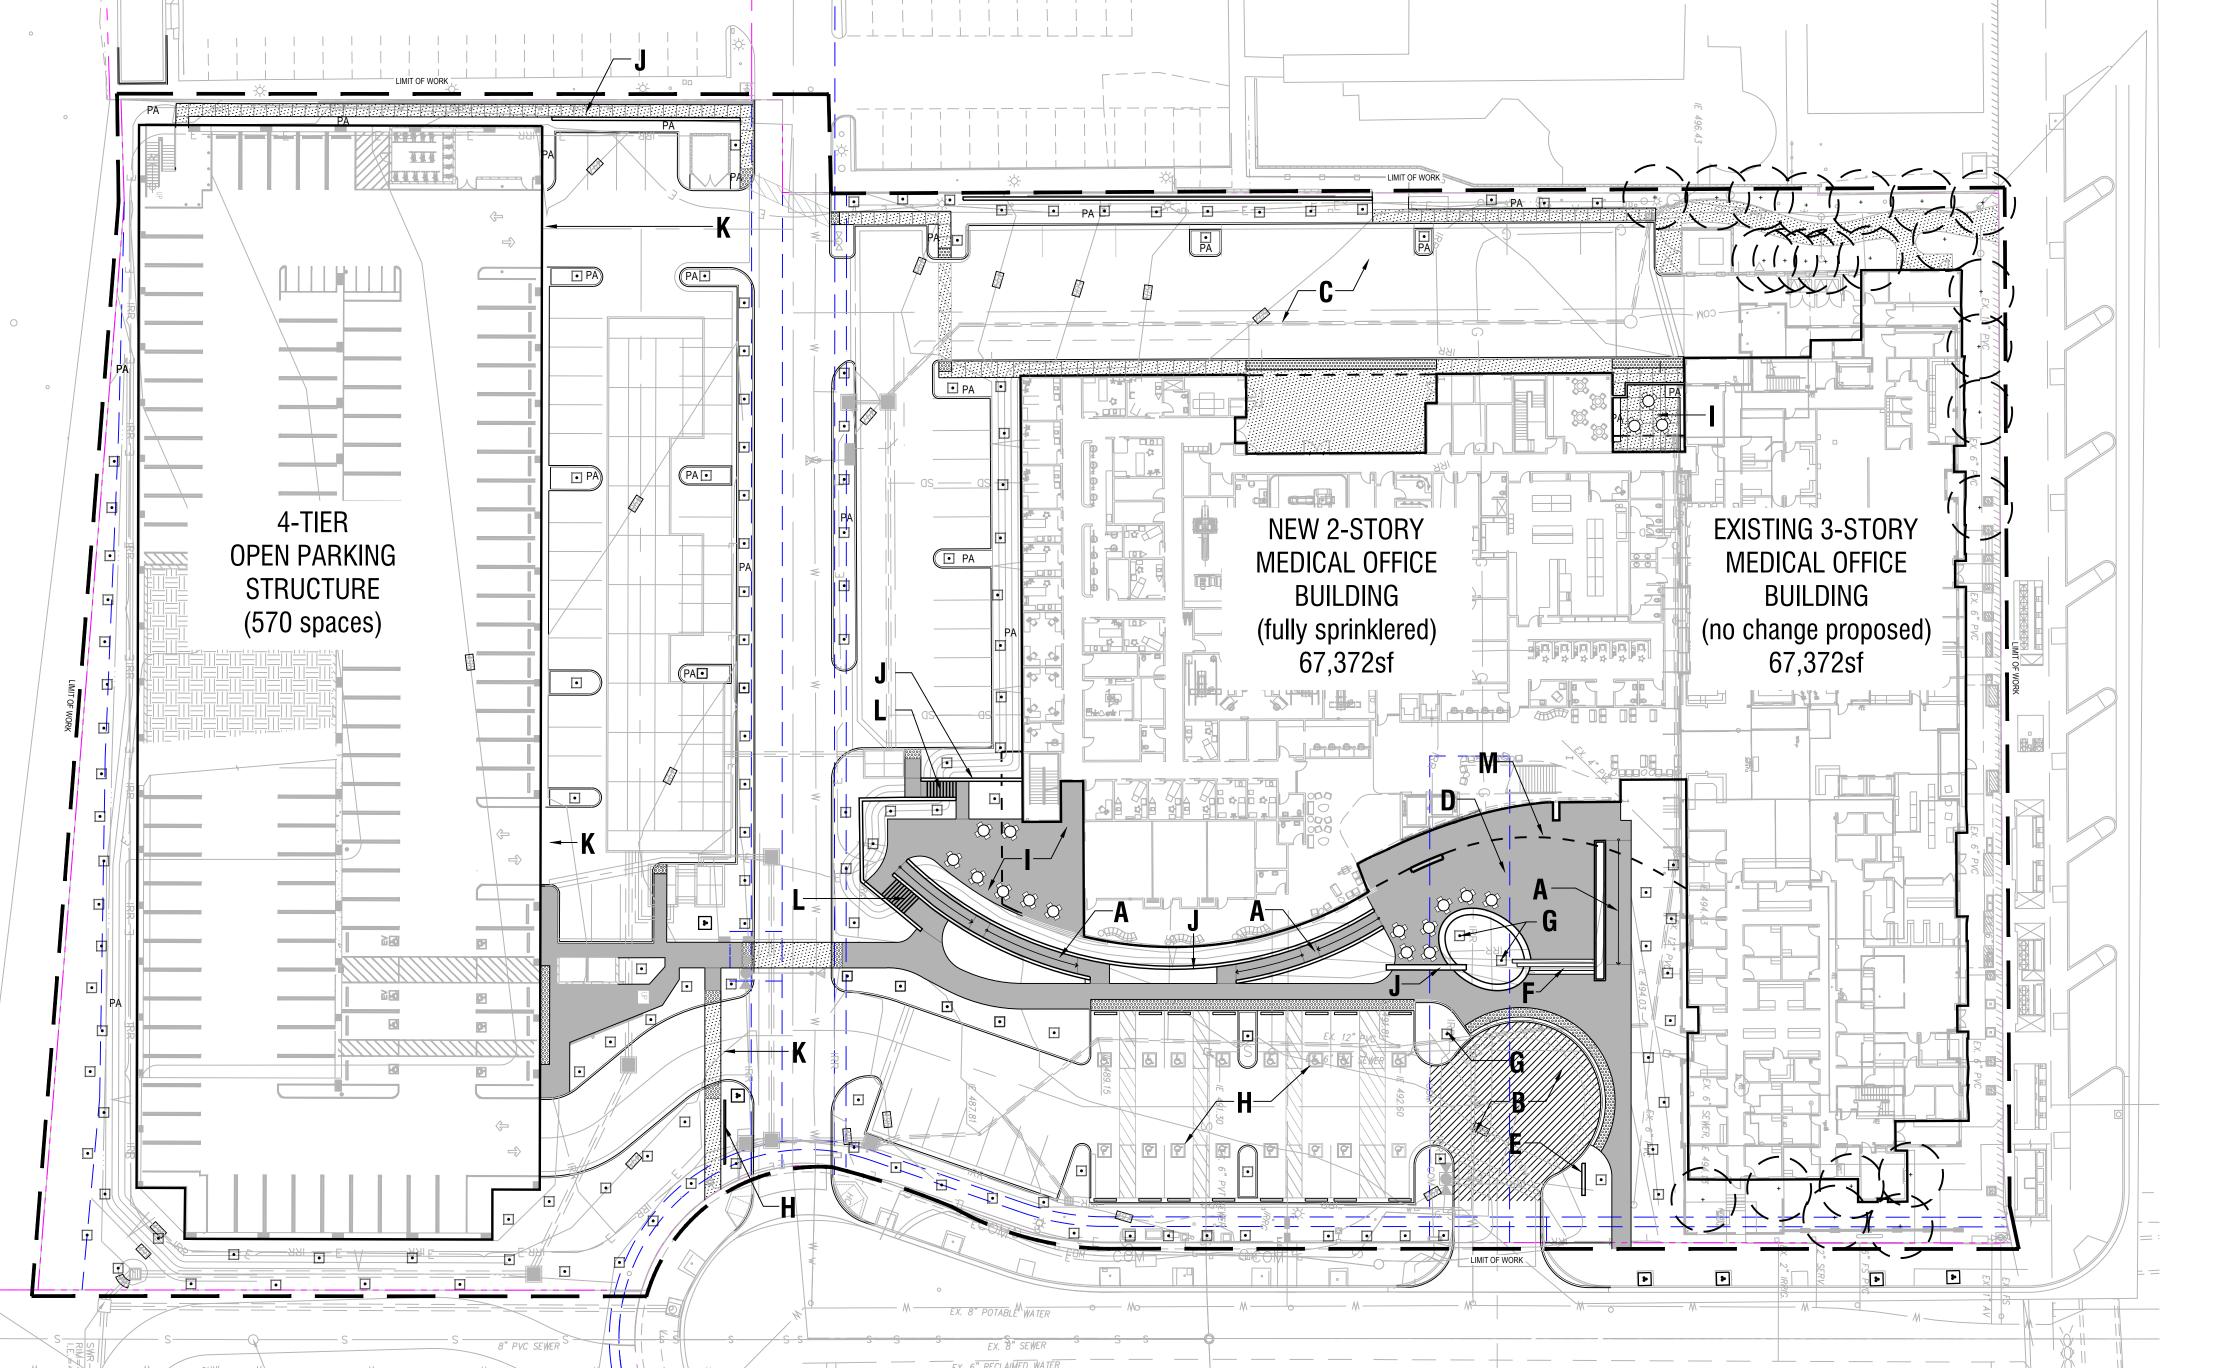



- A ACCESSIBLE RAMP
- **B** ENTRANCE DROP-OFF
- C AMBULANCE PICKUP
- D ENTRY COURTYARD
- **E** SIGNAGE


F TERRACED SEATING

- **G** SPECIMEN TREE
- H ACCESSIBLE PARKINGI DOCTORS' OUTDOOR LOUNGE
- J RETAINING WALL
- K VEHICULAR ACCESS TO PARKING
- L STEPS WITH HANDRAILS
- M CEMENT PLASTER BUILDING CANOPY OVERHANGS ABOVE PER ARCHITECT'S DRAWINGS
- (+) EXISTING TREES TO BE RETAINED


PAVING FINISH LEGEND




ENHANCED CONCRETE PAVING (PEDESTRIAN)-COLORS TO BE CONSISTENT WITH OTAY RANCH

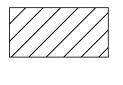

ENHANCED CONCRETE PAVING (VEHICULAR) - COLORS TO BE CONSISTENT WITH OTAY RANCH

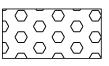

TRUNCATED DOMES

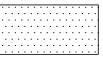

NATURAL GRAY CONCRETE PAVING (PEDESTRIAN)



A R C H I T E C T S

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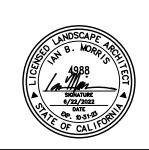




revision schedule

. date

description



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SHARP OTAY RANCH MOB

1400 E. PALOMAR STREET CHULA VISTA, CA 91913

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 2022.06.27

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sheet description


LANDSCAPE CONSTRUCTION PLAN

sheet number


LC101

project phase

CITY OF CHULA VISTA

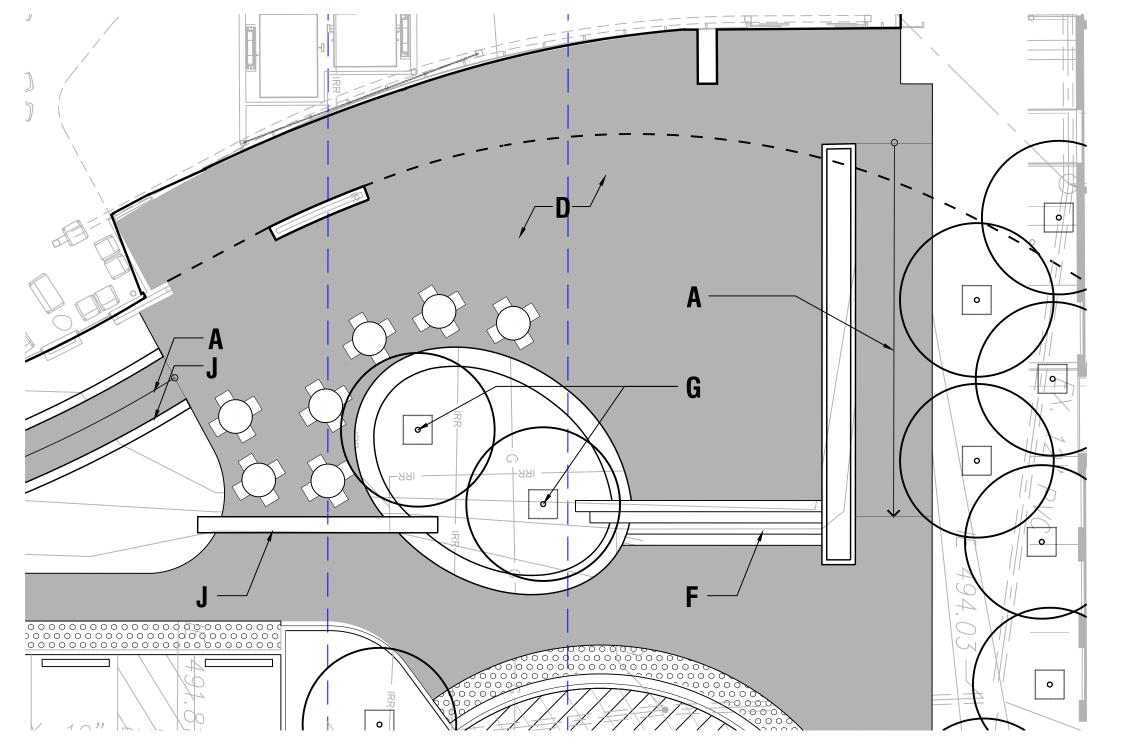

ENLARGEMENT: DOCTOR'S OUTDOOR LOUNGE

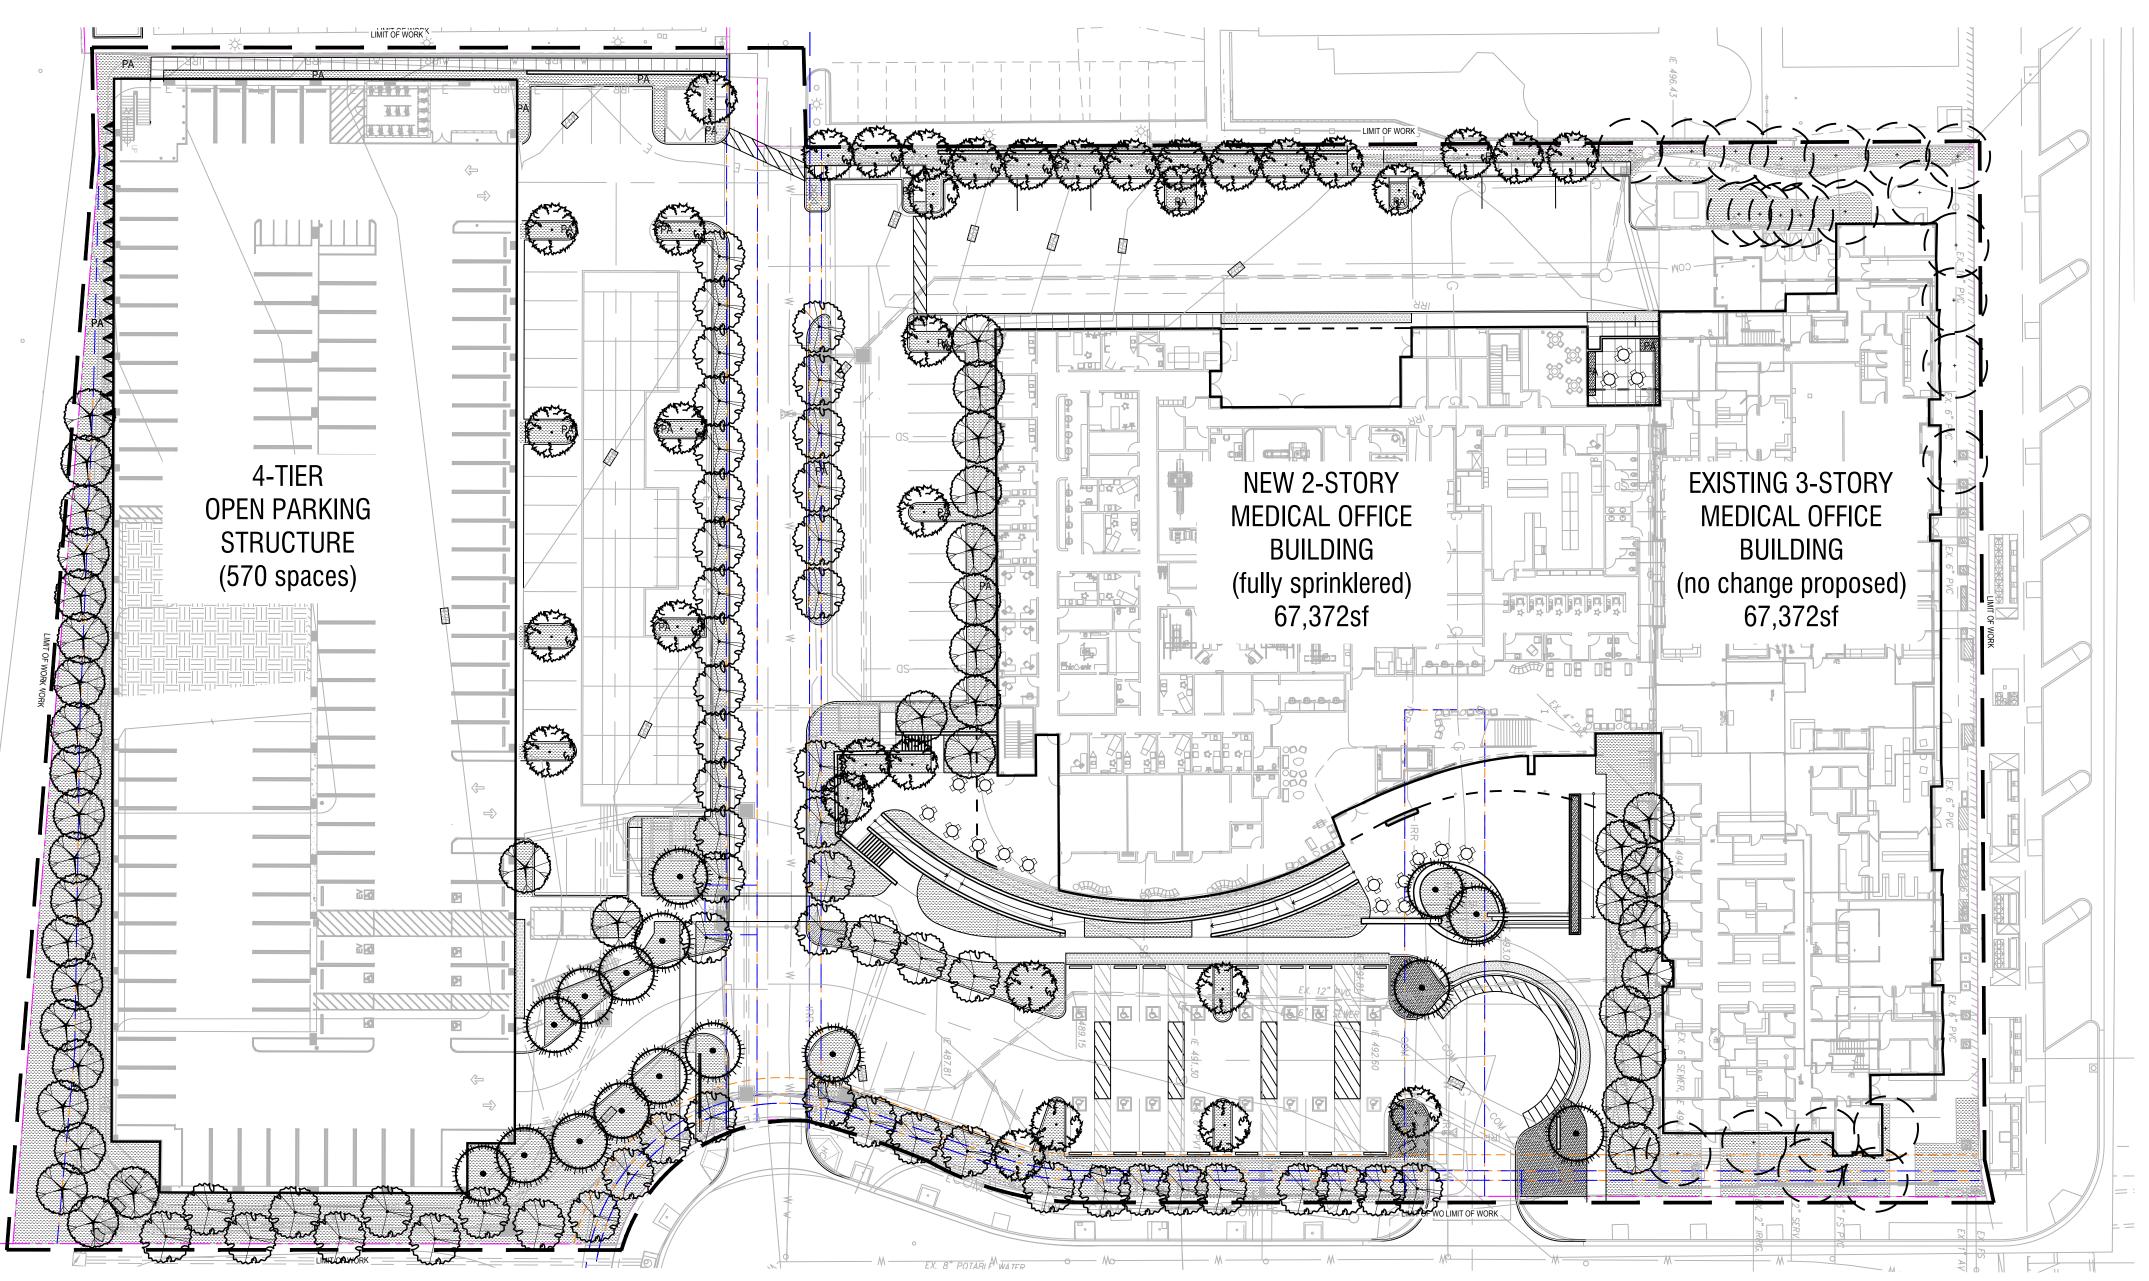

TOTAL SITE AREA IS 207,208 SQ FT.

LANDSCAPE PLANTING AREA IS 30,823 SQ FT.

IRRIGATED AND PLANTED LANDSCAPE OCCUPIES 15% OF THE EXTERIOR SITE AREA

IRRIGATION DESIGN CONCEPT

AN AUTOMATIC, ELECTRICALLY CONTROLLED IRRIGATION SYSTEM SHALL BE PROVIDED AS REQUIRED FOR PROPER IRRIGATION, DEVELOPMENT, AND MAINTENANCE OF THE VEGETATION IN A HEALTHY, DISEASE-RESISTANT CONDITION. THE DESIGN OF THE SYSTEM SHALL PROVIDE ADEQUATE SUPPORT FOR THE VEGETATION SELECTED. THIS SYSTEM WILL BE CONTROLLED BY A DUAL PROGRAM ELECTRONIC TIME CLOCK AND REMOTE CONTROL VALVES POP-UP TYPE HEADS WILL BE USED ADJACENT TO WALKWAYS AND ROADWAYS. BUBBLER HEADS WILL BE USED FOR LANDSCAPED AREAS LESS THAN 6' WIDE. DRIP IRRIGATION OR LOW-FLOW BUBBLERS SHALL BE USED IN PARKING AREAS AND ADJACENT TO LOW-LEVEL BUILDING GLASS. THE SYSTEM WILL BE INSTALLED AS SOON AS POSSIBLE AFTER CONSTRUCTION AND PRIOR TO PLACEMENT OF PLANT MATERIALS.

IF ANY REQUIRED LANDSCAPE INDICATION ON THE APPROVED CONSTRUCTION DOCUMENT PLANS IS DAMAGED OR REMOVED DURING DEMOLITION OR CONSTRUCTION, IT SHALL BE REPAIRED AND/OR REPLACED IN KIND AND EQUIVALENT SIZE PER THE APPROVED DOCUMENTS TO THE SATISFACTION OF THE DEVELOPMENT SERVICES DEPARTMENT WITHIN 30 DAYS OF DAMAGE.

SOIL SAMPLES SHALL BE TAKEN FROM THE SITE AT THE LANDSCAPE ARCHITECT'S DIRECTIVE AND SENT TO A SOIL ANALYSIS LABORATORY TO PERFORM / PROVIDE SOIL AGRONOMIC TEST REPORT(S) PER SPECIFICATIONS. THIS REPORT SHALL BE PERFORMED PRIOR TO START OF PLANTING.

ALL PRUNING SHALL COMPLY WITH THE STANDARDS OF THE AMERICAN NATIONAL INSTITUTE (ANSI) FOR TREE CARE (15) OPERATIONS AND THE INTERNATIONAL SOCIETY OF ARBORICULTURE (ISA) FOR TREE PRUNING. TOPPING TREES IS

SPECIAL INSTRUCTIONS

SOIL AMENDMENTS AS RECOMMENDED. COORDINATE WITH LANDSCAPE ARCHITECT TO CONFIRM TEST LOCATIONS/QUANTITY. CONTRACTOR SHALL ARRANGE A PRE-CONSTRUCTION MEETING WITH LANDSCAPE ARCHITECT TO REVIEW ENTIRE SCOPE OF PLANTING WORK PRIOR TO INSTALLATION. PROVIDE 72 HOUR ALL EXISTING PLANT MATERIAL MUST BE MAINTAINED AT ALL TIMES, UNLESS OTHERWISE NOTED.

CONTRACTOR TO OBTAIN AGRONOMIC SOILS TEST AND IMPLEMENT

POT PLANTING NOTES

- ALL PLANT MATERIAL FOR POTS TO BE RETAIL GRADE STOCK, NO ALL POTS TO RECEIVE 2" LAYER OF 3/8" DIAMETER 'COPPER CANYON'
- GRAVEL MULCH TOPPING. FOR BOTTOM DRAINAGE, ALL POTS TO RECEIVE 3" LAYER OF 3/4" CRUSHED DRAINAGE ROCK WITH FILTER FABRIC. TOP COVER (WRAP UP SIDES 6") IN BOTTOM OF POT.

PLANTING NOTES

2	TRIPLE STAKE TREES, UNLESS NOTED OTHERWISE.
3	TREE ROOT BARRIERS SHALL BE INSTALLED WHERE TREES ARE PLACED WITHIN 5 FEET OF PUBLIC IMPROVEMENTS INCLUDING WALKS, CURBS, OR STREET PAVEMENTS OR WHERE NEW PUBLIC IMPROVEMENTS ARE PLACED ADJACEN' TO EXISTING TREES. THE ROOT BARRIER WILL NOT WRAP ARQUIND THE ROOT BALL

1 TREES ARE STANDARD FORM UNLESS NOTED OTHERWISE.

WHERE SPREADING GROUNDCOVERS ARE SHOWN TO BE PLANTED ADJACENT TO A CURB OR WALKWAY EDGE, SET CENTER OF PLANT 24" OFF HARD SURFACE.

AFFIC SIGNALS / STOP SIGNS.... UNDERGROUND UTILITY LINES......5 FT (10' FOR SEWER). ABOVE GROUND UTILITY STRUCTURES..... DRIVEWAYS (ENTRIES)... INTERSECTIONS (INTERSECTING CURB LINES OF TWO STREETS)

ALL LANDSCAPE AND IRRIGATION SHALL CONFORM TO THE STANDARDS OF THE CITY-WIDE LANDSCAPE REGULATIONS AND ALL OTHER LANDSCAPE RELATED CITY AND REGIONAL

A MINIMUM ROOT ZONE OF 40SF IN AREA SHALL BE PROVIDED 7 FOR ALL TREES. THE MINIMUM DIMENSION FOR THIS AREA

MAINTENANCE: ALL REQUIRED LANDSCAPE SHALL BE MAINTAINED BY OWNER. LANDSCAPE AND IRRIGATION IN THE PUBLIC RIGHT-OF-WAY SHALL BE MAINTAINED BY OWNER. THE LANDSCAPE AREAS SHALL BE MAINTAINED FREE OF DEBRIS AND LITTER, AND ALL PLANT MATERIAL SHALL BE MAINTAINED IN A HEALTHY GROWING CONDITION. DISEASED OR DEAD PLANT MATERIAL SHALL BE SATISFACTORILY TREATED OR REPLACED PER THE CONDITIONS OF THE PERMIT.

TREES SHALL BE MAINTAINED SO THAT ALL BRANCHES OVER PEDESTRIAN WALKWAYS ARE 6 FEET ABOVE THE WALKWAY GRADE AND BRANCHES OVER VEHICULAR TRAVEL WAYS ARE 16 FEET ABOVE THE GRADE OF THE TRAVEL WAY.


PROTECTION MEASURES WILL BE PROVIDED: A BRIGHT YELLOW OR ORANGE TEMPORARY FENCE WILL BE PLACED AROUND EXISTING TREES AT THE DRIP LINE. STOCKPILING, TOPSOIL DISTURBANCE, VEHICLE USE, AND MATERIAL STORAGE OF ANY KIND IS PROHIBITED WITHIN THE DRIP LINE. DOCUMENTED DURING CONSTRUCTION.

EXISTING TREES TO REMAIN ON SITE WITHIN THE AREA OF WORK WILL BE PROTECTED IN PLACE. THE FOLLOWING

. A TREE WATERING SCHEDULE WILL BE MAINTAINED AND ALL DAMAGED TREES WILL BE REPLACED WITH ONE OF EQUAL OR GREATER SIZE. MULCH: ALL REQUIRED PLANTING AREAS AND ALL EXPOSED SOIL AREAS WITHOUT VEGETATION SHALL BE COVERED WITH MULCH TO A MINIMUM DEPTH OF 3", EXCLUDING SLOPES

REQUIRING REVEGETATION PER SDMC 142.0411.



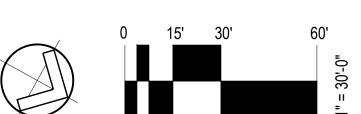

PLANTING LEGEND

ACCENT TREES

PERIMETER SCREEN TREES

STREET TREES

EXISTING TREES

FEATURE SUCCULENT PLANTING

SHRUB AND GRASS PLANTING

BOTANICAL NAME

CRAPE MYRTLE

MADRONES

PALO VERDE

DRAGON TREE

MADAGASCAR DRAGON TREE

WESTERN SYCAMORE

MOZAMBIQUE TREE ALOE

SILVER SHEEN KOHUHU

HERCULES ALOE

BAY LAUREL

LOPHOSTEMON

FERN PODOCARPUS

SOUTHERN LIVE OAK

MAGNOLIA

BRISBANE BOX

STRAWBERRY TREE

SOUTHERN LIVE OAK

AFRICAN FERN TREE

SOUTHERN LIVE OAK

AFRICAN FERN TREE

PALO VERDE

DRAGON TREE

ROSEMARY

WAXLEAF PRIVET

YELLOWWOOD

MAT RUSHES

CANYON PRINCE WILD RYE

FOUNTAIN GRASS

NATAL PLUM

HAWTHORNE

ROCKROSE

DEERGRASS

CALIFORNIA LILACS

AUTUMN MOOR GRASS

EVERGREEN FOUNTAIN GRASS

COMMON NAME

CALIFORNIA WILD ROSE

MOCK ORANGE

MANZANITA

FLAME VINE

TOYON

BRIGHT AND TIGHT CAROLINA LAUREL

FLAX LILY

COMMON NAME

AFRICAN SUMAC

36" BOX LAGERSTROEMIA INDICA

36" BOX CERCIDIUM x 'DESERT MUSEUM'

36" BOX ARBUTUS SP.

36" BOX OLEA EUROPAEA

36" BOX DRACAENA DRACO

36" BOX QUERCUS SP.

36" BOX DRACAENA MARGINATA

36" BOX PLATANUS RACEMOSA

36" BOX ALOE 'HERCULES'

36" BOX ALOE 'MEDUSA'

36" BOX LAURUS NOBILIS

36" BOX PITTOSPORUM 'SILVER SHEEN'

36" BOX TRISTANIA CONFERTA

36" BOX PODOCARPUS GRACILIOR

36" BOX LOPHOSTEMON CONFERTUS

36" BOX QUERCUS VIRGINIANA

36" BOX MAGNOLIA SP.

36" BOX RHUS LANCEA

36" BOX FRAXINUS SP.

36" BOX ULMUS SP.

EXISTING TREE TO REMAIN

36" BOX AGAVE SP.

36" BOX ALOE SP.

SIZE

36" BOX AEONIUM SP.

36" BOX EUPHORBIA INGENS

5 GAL WESTRINGIA SP.

5 GAL PODOCARPUS SP.

5 GAL LOMANDRA SP.

5 GAL DIANELLA SP.

5 GAL SALVIA SP.

5 GAL CARISSA SP.

5 GAL CISTUS SP.

5 GAL

5 GAL LIGUSTRUM 'TEXANUM'

5 GAL LEYMUS 'CANYON PRINCE'

5 GAL PENNISETUM 'BUNNY TAILS'

CEANOTHUS SP.

RHAPHIOLEPIS SP.

SESLERIA AUTUMNALIS

MUHLENBERGIA RIGENS

ROSA CALIFORNICA

PITTOSPORUM SP.

5 GAL HETEROMELES ARBUTIFOLIA

15 GAL PYROSTEGIA VENUSTA

ARCTOSTAPHYLOS SP.

BOTANICAL NAME

PENNISETUM 'FAIRY TAILS'

PRUNUS CAROLINIANA 'BRIGHT AND

36" BOX | SCENECIO MANDRALISCAE

BOTANICAL NAME

PARKING LOT SHADE TREES 36" BOX ULMUS SP.

36" BOX QUERCUS VIRGINIANA

36" BOX QUERCUS VIRGINIANA

36" BOX PODOCARPUS GRACILIOR

36" BOX PODOCARPUS GRACILIOR

ARCHITECTS hanna gabriel wells

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SHARP Rees-Stealy Medical Centers



GROUNDLEVEL LANDSCAPE ARCHITECTURE 2605 State Street, Suite B San Diego, CA 92103 619 234 1010 GroundLevelSD.com

revision schedule

GL Project #21046

project

date

SHARP OTAY RANCH MOB

CHULA VISTA, CA 91913 2022.06.27

1400 E. PALOMAR STREET

hgw project number 21.45 agency project number ENVIRONMENTAL: IS21-0005 DESIGN REVIEW: DR21-0029 CONDITION USE: CUP21-0019

LANDSCAPE PLANTING PLAN

sheet number

project phase

Design Review Sharp Rees-Stealy Otay Ranch Expansion— IS210005 Conceptual Grading Plans

GRADING NOTES

- 1. ALL WORK SHALL BE DONE IN ACCORDANCE WITH THESE APPROVED PLANS AND APPROVED REVISIONS. ANY CHANGES OR REVISIONS THEREFROM SHALL BE APPROVED BY THE CITY ENGINEER AND MITIGATION MONITOR PRIOR TO ANY REQUEST FOR INSPECTION.
- 2. ALL GRADING SHALL BE INSPECTED AND TESTED BY OR UNDER THE DIRECTION OF A QUALIFIED SOILS ENGINEER. THE SOILS ENGINEER SHALL INSPECT THE EXCAVATION, AND SHALL OBSERVE AND TEST THE PLACEMENT, AND COMPACTION OF FILL AND BACKFILL AND COMPACTION OF TRENCHES; SUBMIT GEOTECHNICAL OR SOILS REPORTS AS REQUIRED AND DETERMINE THE SUITABILITY OF ANY FILL MATERIAL UPON COMPLETION OF GRADING OPERATIONS. THE SOILS ENGINEER SHALL STATE THAT OBSERVATIONS AND TESTS WERE MADE BY, OR UNDER DIRECTION OF THE SOILS ENGINEER, AND THAT EMBANKMENTS AND EXCAVATIONS WERE CONSTRUCTED IN ACCORDANCE WITH THE GEOTECHNICAL ASPECTS OF THE APPROVED GRADING PLANS. ANY APPROVED REVISIONS THERETO, SUBJECT LAND DEVELOPMENT PERMIT AND ORDINANCE NO. 1797 AS AMENDED, AND THAT ALL EMBANKMENTS AND EXCAVATIONS ARE ACCEPTABLE FOR THEIR INTENDED USE.
- 3. THE CONTRACTOR SHALL PROPERLY GRADE ALL EXCAVATED SURFACES TO PROVIDE POSITIVE DRAINAGE AND PREVENT PONDING OF WATER. CONTRACTOR SHALL CONTROL SURFACE WATER TO AVOID DAMAGE TO ADJOINING PROPERTIES OR TO FINISHED WORK ON THE SITE, AND SHALL TAKE REMEDIAL MEASURES TO PREVENT EROSION OF FRESHLY GRADED AREAS UNTIL SUCH TIME AS PERMANENT DRAINAGE AND EROSION CONTROL MEASURES HAVE BEEN INSTALLED TO THE SATISFACTION OF THE CITY ENGINEER AND THE MITIGATION MONITOR.
- 4. ALL AREAS TO BE FILLED SHALL BE PREPARED PRIOR TO FILLING, AND FILL SHALL BE PLACED IN ACCORDANCE WITH STANDARD SPECIFICATIONS AND THE RECOMMENDATIONS AND SPECIFICATIONS CONTAINED IN THE SOILS REPORT. ALL VEGETABLE MATTER AND OTHER OBJECTIONABLE MATERIALS SHALL BE REMOVED, BY THE CONTRACTOR, FROM THE SURFACE UPON WHICH THE FILL IS TO BE PLACED. LOOSE FILL AND UNSUITABLE SOILS SHALL BE REMOVED TO SUITABLE FIRM NATURAL GROUND. THE EXPOSED SOILS SHALL BE SCARIFIED IN ACCORDANCE WITH THE GEOTECHNICAL REPORT AND THEN COMPACTED TO A MINIMUM OF 90% OF ASTM-D1557. IT SHALL BE THE CONTRACTOR'S RESPONSIBILITY TO PLACE, SPREAD. WATER AND COMPACT THE FILL IN STRICT ACCORDANCE WITH THE SPECIFICATIONS.
- 5. CUT AND FILL SLOPES SHALL BE CUT AND TRIMMED TO THE FINISHED GRADE TO PRODUCE SMOOTH SURFACES AND UNIFORM CROSS SECTIONS. THE SLOPES OF EXCAVATIONS AND EMBANKMENTS SHALL BE SHAPED. TRIMMED. AND PLANTED IN ACCORDANCE WITH THE PLANTING NOTES AND AS DIRECTED BY THE ENGINEER OF WORK, AND LEFT IN A NEAT AND ORDERLY CONDITION. ALL STONES, ROOTS AND OTHER WASTE MATERIALS EXPOSED ON THE EXCAVATION OR EMBANKMENT SLOPES WHICH ARE LIABLE TO BECOME LOOSENED, SHALL BE REMOVED AND DISPOSED OF. THE TOE AND TOP OF ALL SLOPES SHALL BE ROUNDED IN ACCORDANCE WITH ORDINANCE NO. 1797, THESE GRADING PLANS, AND THE STANDARD DRAWINGS GRD-01 AND GRD-02. SLOPE SETBACKS AND GRADES SHALL CONFORM TO GRD-06.
- 6. IF THERE ARE EROSION SCARS ON EXISTING SLOPES WHICH OTHERWISE WOULD NOT BE ELIMINATED BY THE PROPOSED GRADING. THESE SCARS ARE TO BE ELIMINATED BY TRIMMING. FINE GRADING AND PLANTING. IF THE SCARS ARE IN AREAS OF NATIVE VEGETATION, THE REPAIRS SHOULD BE PERFORMED WITH AN EFFORT TO AVOID OR MINIMIZE IMPACTS TO NATIVE VEGETATION. ALL SUCH REPAIRS IN AREAS OF NATIVE VEGETATION SHALL BE REVIEWED AND APPROVED BY THE CITY'S MITIGATION MONITORING COORDINATOR PRIOR TO THE BEGINNING OF THE REPAIR WORK.
- 7. ALL TREES, BRUSH, GRASS, AND OTHER OBJECTIONABLE MATERIAL SHALL BE COLLECTED, PILED OR OTHERWISE DISPOSED OF OFF THE SITE BY THE CONTRACTOR SO AS TO LEAVE THE AREAS THAT HAVE BEEN CLEARED WITH A NEAT AND FINISHED APPEARANCE FREE FROM UNSIGHTLY DEBRIS. APPROVAL OF LOCATIONS FOR DEBRIS FILL SHALL BE OBTAINED FROM THE SOILS ENGINEER PRIOR TO THE DISPOSAL OF ANY SUCH MATERIAL.
- 8. SUBDRAIN LOCATIONS SHOWN ARE APPROXIMATE AND ARE RECOMMENDED FOR ALL SIGNIFICANT FILL CANYONS. THE ACTUAL LOCATION AND EXTENT OF SUBDRAINS SHALL BE DETERMINED BY THE GEOTECHNICAL CONSULTANT AT THE TIME OF CONSTRUCTION.
- 9. THE SOILS REPORT TITLED <u>UPDATED GEOTECHNICAL INVESTIGATION SHARP OTAY RANCH</u> MEDICAL OFFICE BUILDING AND PARKING STRUCTURE PROJECT, 1400 EAST PALOMAR STREET, CHULA VISTA CALIFORNIA, FROM LEIGHTON CONSULTING INC. DATED AUGUST 23, 2021, <u>PROJECT NO. 13229.001,</u> SHALL BE CONSIDERED TO BE PART OF THIS GRADING PLAN. ALL GRADING SHALL BE DONE IN ACCORDANCE WITH THE RECOMMENDATIONS AND SPECIFICATIONS CONTAINED IN SAID REPORT.
- 10. CONTRACTOR SHALL VERIFY LOCATIONS OF ALL EXISTING UNDERGROUND UTILITIES. LOCATIONS SHOWN ON THESE PLANS ARE APPROXIMATE AND SHOWN FOR GENERAL INFORMATION ONLY.
- 11. WHERE GRADING DOES NOT OCCUR, ALL EXISTING PLANT MATERIAL IS TO BE PROTECTED IN PLACE. NO CONSTRUCTION EQUIPMENT WILL BE ALLOWED TO TRAVEL THROUGH AND DAMAGE ANY OF THESE AREAS. ALL AREAS TO BE RETAINED IN A NATURAL CONDITION SHALL BE FENCED UNDER THE DIRECTION OF THE PROJECT BIOLOGIST. CONTRACTOR WILL BE RESPONSIBLE TO REPAIR ANY AND ALL DAMAGE/IMPACTS TO THESE AREAS.
- 12. THE CONTRACTOR SHALL FURNISH TO THE ENGINEER OF WORK AS-BUILT PLANS FOR ALL NEW IMPROVEMENTS AND GRADING SHOWN ON THESE PLANS FOR SUBMITTAL TO THE CITY ENGINEER FOR APPROVAL IN ACCORDANCE WITH SECTION 15.04.140 OF THE CHULA VISTA MUNICIPAL CODE.
- 13. IN THE CASE OF CONFLICTS, THE REQUIREMENTS OF THE EARTHWORK, SPECIFICATIONS PREPARED FOR THE PROJECT BY THE SOILS ENGINEER SHALL GOVERN THE REQUIREMENTS OF THIS PLAN AND THESE NOTES AND THESE PLANS SHALL BE REVISED ACCORDINGLY.

SECTION 4215/4217 OF THE GOVERNMENT CODE REQUIRES THAT A DIG ALERT IDENTIFICATION

NUMBER BE ISSUED BEFORE A "PERMIT TO EXCAVATE" WILL BE VALID. PER YOUR DIG ALERT I.D. NUMBER CALL UNDERGROUND SERVICE ALERT TOLL FREE 1-800-422-4133 TWO WORKING

JNDERGROUND SERVICE ALERT

CALL: TOLL FREE (800)422-4133

TWO WORKING DAYS BEFORE YOU DIG

"CAUTION": REMEMBER THAT THE USA CENTER NOTIFIES ONLY THOSE UTILITIES BELONGING TO THE CENTER. THERE COULD BE OTHER UTILITIES PRESENT AT THE WORK SITE. THE CENTER WILL INFORM YOU OF WHOM

GENERAL NOTES


1. STORM DRAINS ARE SHOWN FOR INFORMATIONAL PURPOSES ONLY. APPROVAL OF THIS PLAN DOES NOT CONSTITUTE APPROVAL OF SIZES. LOCATIONS. AND TYPE OF SEWER AND DRAINAGE FACILITIES, OR ANY SURFACE IMPROVEMENTS WITHIN FUTURE STREET RIGHTS-OF-WAY SHOWN ON THESE PLANS. SEPARATE APPROVALS AND PERMITS FOR THESE SHALL BE REQUIRED IN CONJUNCTION WITH IMPROVEMENT PLANS.

2.WRITTEN PERMISSION SHALL BE OBTAINED FOR ANY OFF-SITE GRADING

- 3. CONTRACTOR SHALL TAKE ALL NECESSARY PRECAUTIONS REQUIRED TO PROTECT ADJACENT PROPERTIES DURING GRADING OPERATIONS. ANYTHING DAMAGED OR DESTROYED SHALL BE REPLACED OR REPAIRED TO CONDITION EXISTING PRIOR TO GRADING.
- 4. THE DEVELOPER/CONTRACTOR SHALL BE RESPONSIBLE FOR SURVEY MONUMENTS AND/OR VERTICAL CONTROL BENCHMARKS WHICH ARE DISTURBED OR DESTROYED BY CONSTRUCTION. A LAND SURVEYOR MUST FIELD LOCATE, REVERENCE, AND/OR PRESERVE ALL HISTORICAL PROPOSED IMPROVEMENTS; AND IF DESTROYED, A LANDS SURVEYOR, OR A CIVIL ENGINEER AUTHORIZED TO PRACTICE LAND SURVEYING SHALL REPLACE SUCH MONUMENTS WITH THE APPROPRIATE MONUMENTS. A CORNER RECORD OR RECORD OF SURVEY, AS APPROPRIATE MONUMENTS. A CORNER RECORD OR RECODE OF SURVEY, AS APPROPRIATE, SHALL BE FILED AS REQUIRED BY THE PROFESSIONAL LANDS SURVEYOR ACT. THE DEVELOPER/CONTRACTOR WILL BE RESPONSIBLE FOR THE COST OF REPLACING ANY VERTICAL BENCHMARK'S DESTROYED BY THE CONSTRUCTION.
- 5.THE CONTRACTOR SHALL DESIGN, CONSTRUCT, AND MAINTAIN ALL SAFETY DEVICES, INCLUDING SHORING, AND SHALL BE RESPONSIBLE FOR CONFORMING TO ALL LOCAL, STATE, AND FEDERAL SAFETY AND HEALTH STANDARDS, LAWS, AND REGULATIONS.

6. ALL FLOWS SHOWN ARE FOR 50 - YEAR STORM, EXCEPT AS NOTED.

- 7. ALL SEDIMENTATION BASINS, OUTLET PIPES AND DITCHES ARE PRIVATE UNLESS OTHERWISE NOTED AND HAVE NOT BEEN REVIEWED FOR ADEQUACY BY THE CITY ENGINEERING DEPARTMENT.
- 8.THE OWNER MUST OBTAIN AN EXCAVATION PERMIT FROM THE DIVISION OF OCCUPATIONAL SAFETY AND HEALTH (D.O.S.H.) FOR CONSTRUCTION OF TRENCHES OR EXCAVATIONS WHICH ARE FIVE FEET OR DEEPER INTO WHICH A PERSON IS REQUIRED TO DESCEND. SAID PERMIT IS REQUIRED PRIOR TO ISSUANCE OF A GRADING PERMIT BY THE CITY OF CHULA VISTA.
- 9. GRADING EQUIPMENT SHALL NOT USE OR BLOCK TRAFFIC LANES DURING GRADING ACTIVITY, TRUCK OPERATIONS IN AND OUT OF CONSTRUCTION AND STAGING AREAS SHALL BE CONTROLLED AS REQUIRED BY THE CITY. TRUCK AND EQUIPMENT ROUTES IN AND OUT OF THE SITE, SHALL BE APPROVED BY THE CITY PRIOR TO START OF WORK. AT THE END OF THE WORKING DAY, STREETS SHALL BE CLEANED OF DIRT AND CONSTRUCTION DEBRIS TO THE SATISFACTION OF THE CITY INSPECTOR AND THE MITIGATION MONITOR.
- 10. DUST GENERATED BY CONSTRUCTION ACTIVITIES SHALL COMPLY WITH LOCAL DUST CONTROL, ANY REQUIREMENTS OF ANY MITIGATION MONITORING PROGRAMS, AND UNIFORM BUILDING CODE (UBC) REQUIREMENTS, WHICH INCLUDE DUST CONTROL MEASURES FOR CONSTRUCTION SITES. DUST REDUCING MEASURES SHALL INCLUDE, BUT NOT LIMITED TO, REGULAR WATERING OF GRADED SURFACES AND RESTRICTION OF ALL CONSTRUCTION VEHICLES AND EQUIPMENT TO TRAVEL ALONG ESTABLISHED AND REGULARLY WATERED ROADWAYS AT SPECIFIED SPEEDS.
- 11. ALL STORM DRAIN PIPE SHALL BE1500 D-LOAD UNLESS OTHERWISE SHOWN ON THESE PLANS. ALL STORM DRAIN NEEDS TO BE CONSTRUCTED PER THE GRADING AND DRAINAGE PLANS.

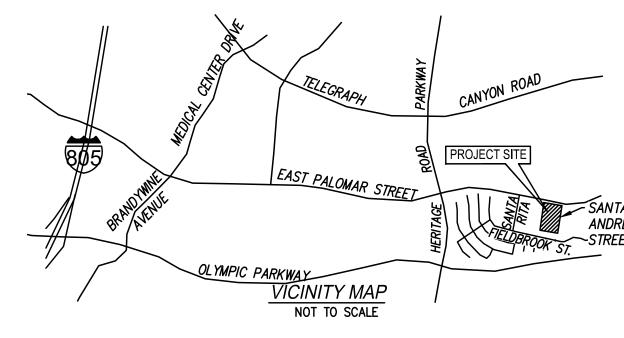

SURVEY INFORMATION

AERIAL SURVEY PREPARED BY BDS ENGINEERING INC. ON 08/23/2021. 5575 LAKE PARK WAY SUITE 114 LA MESA, CALIFORNIA 92942 (619) 582-4992

BASIS OF BEARING

BENCHMARK

CP #50 NAIL & SHINER N-1807431.50 E-6332206.22 ELEV-498.44 CP #51 NAIL & SHINER N-1807226.80 E-6332266.26

LEGAL DESCRIPTION

THE LAND PREFERRED TO HEREIN BELOW IS LOCATED IN THE CITY OF CHULA VISTA, COUNTY OF SAN DIEGO, STATE OF CALIFORNIA, AND IS DESCRIBED AS FOLLOWS:

LOT 5 OF CHULA VISTA TRACT NO. 96-04A, IN THE CITY OF CHULA VISTA, COUNTY OF SAN DIEGO, STATE OF CALIFORNIA, ACCORDING TO MAP THEREOF NO. 13990 FILED IN THE CITY OF SAN DIEGO COUNTY RECORDER JUNE 27, 2000.

SUBJECT TO THOSE RESERVATIONS AND RIGHTS CONTAINED IN THAT CERTAIN GRANT DEED RECORDED DECEMBER 9, 1999 AS FILE NO. 1990-0801542, OF OFFICIAL RECORDS

APN: 642-560-01-00

REFERENCE DRAWINGS

PALOMAR STREET IMP. PLAN PER CITY DWG NO. 98-281 SANTA ANDREA STREET IMP. PLAN PER CITY DWG. 99-778 STORM DRAIN PER CITY DWG. NO. 99-473 SHARP MEDICAL OFFICES OTAY RANCH PER BUILDING PROJECT NO. 99551-01 CIVIL SITE PLAN PER BUILDING PERMIT NO. 152-01

FLOOD ZONE NOTE:

BASED ON THE US DEPARTMENT OF HOUSING AND URBAN DEVELOPMENT, FEDERAL INSURANCE ADMINISTRATION FLOOD HAZARD BOUNDARY MAP. COMMUNITY NUMBER 060 73C, SHEET NUMBER 2176G DATED 05/16/2012, THE SUBJECT PROPERTY IS NOT LOCATED IN A SPECIAL FLOOD HAZARD AREA ACCORDING TO THE MAP.

CONSULTANT BACKGROUND DRAWINGS

SHFFT INDEX

<u>OTTEET INBEST</u>	
TITLE SHEET	CO.0
KEY MAP AND SECTIONS	. CO.1
EXISTING CONDITION AND PARTIAL DEMOLITION PLAN	C1.0
GRADING PLAN	.C2.0-C2.1
PRIVATE STORM DRAIN AND UTILITIES PLAN	C3.0-C3.1
HORIZONTAL CONTROL/SURFACE IMPROVEMENTS PLAN	C4.0
EROSION CONTROL PLAN	. C5.0
EROSION CONTROL DETAILS PLAN	. C5.1
FIRE AND WASTE/RECYCLING TRUCK ACCESS PLAN	C6.0



THE WORK TO BE DONE CONSISTS OF THE ITEMS INDICATED UNDER THE "LEGEND" SHOWN BELOW, AND IS TO BE DONE IN ACCORDANCE WITH THESE PLANS AND THE FOLLOWING LIST OR PRINTED MATERIALS AS CURRENTLY ADOPTED BY THE CITY OF CHULA VISTA CITY COUNCIL INCLUDING THE FOLLOWING:

1. 2012 STANDARD SPECIFICATIONS FOR PUBLIC WORKS CONSTRUCTION ("GREENBOOK") AND 2012 REGIONAL SUPPLEMENT AMENDMENTS (TO THE GREENBOOK).

2. 2012 SAN DIEGO AREA REGIONAL STANDARD DRAWINGS.

3. 2019 CITY OF CHULA VISTA STANDARD SPECIAL PROVISIONS (TO THE GREENBOOK).

4. 2017 DESIGN AND CONSTRUCTION STANDARDS OF THE CITY OF CHULA VISTA.

5. PORTION OF THE STATE STANDARD SPECIFICATIONS. STATE OF CALIFORNIA. DEPARTMENT OF TRANSPORTATION, DATED JULY 2010 AND ALL SUBSEQUENT ADDITIONS AND REVISIONS.

6. PORTION OF THE STATE STANDARD PLANS. STATE OF CALIFORNIA. DEPARTMENT OF TRANSPORTATION. DATED JULY 2010 AND ALL SUBSEQUENT ADDITIONS AND REVISIONS.

7. 2014 CALIFORNIA MANUAL ON UNIFORM TRAFFIC CONTROL DEVICES ("CA-MUTCD") AND ALL SUBSEQUENT ADDITIONS AND REVISIONS.

8. WATER AGENCIES STANDARDS SPECIFICATIONS FOR RECYCLED WATER AND SEWER FACILITIES, LATEST EDITION.

9. PUBLIC WATER SYSTEM IMPROVEMENTS SHALL BE INSTALLED IN ACCORDANCE WITH THE SWEETWATER AUTHORITY'S DESIGN STANDARDS AND STANDARD SPECIFICATIONS FOR CONSTRUCTION OF WATER FACILITIES.

ALL REFERENCES ARE TO BE MADE PART OF THESE PLANS. ANY CHANGES OR REVISIONS THEREFROM, SHALL BE APPROVED BY THE CITY ENGINEER, OR HIS DESIGNEE, PRIOR TO ANY REQUEST FOR INSPECTION.

LEGEND PROPOSED IMPROVEMENTS

PROP STORM DRAIN TYPE A-4 CLEANOUT (PVT)

PROP STORM DRAIN CURB INLET (PVT).

<u>ITEM</u>	<u>SYMBOL</u>
PROPOSED IMPROVEMENTS	
PROP BLDG PAD.	
IMITS OF WORK	
TOP OF CURB ELEVATION	TI 400.00
FLOW LINE ELEVATION	FL 100.00
FINISH SURFACE ELEVATION	FS 100.00
MAJOR CONTOUR	
MINOR CONTOUR	<u> </u>
DRAINAGE FLOW	
PROP MODULAR WETLAND UNIT (PVT) PER CITY DWG NO. XXXXXXX	

PER. CITY. DWG .NO. XXXXXX.

.PER .CITY .DWG .NO. .XXXXXX

PROP. CATCH BASIN BROOKS BOX (PVT)	
PROP STORMTRAP VAULT STORAGE (PVT). PER CITY DWG NO. XXXXXX	
PROP PVC STORM DRAIN PIPE (PVT)PER.CITY.DWG.NO.XXXXXXX.	
PROP STORM DRAIN CLEANOUT. PER CITY DWG NO. XXXXXXX =	= ==
* PROP FIRE SERV. BACKFLOW PREVENTOR (PVT)	⋙ — F—
* DOOD WATER SERV METER W/DACKELOW	×1048)— W—[]
* PROP. FIRE HYDRANT	- F
PROP TYPE G 6" CURB AND GUTTER (PVT)	
PROP 6" CURB (PVT)	
PROP PARKING STALL (PVT).	

PROP AC PAVING (PVT) PROP PCC DRIVEWAY (PUB) PROPOSED CURB RAMP... CONCRETE PAVING PROP SAWCUT LINE. PROP. BROW DITCH. EXISTING DIRECTION OF FLOW.

PROP RETAINING WALL (PVT) * PER OTAY WATER DISTRICT PROJECT NO. XXX-XXXXX

EVICTING IMPROVEMENTS

EXISTING ASPHALT...

EXISTING DIRECTION OF FLOW.

EXISTING IMPROVEMENTS	
<u>ITEM</u>	<u>SYMBOL</u>
PROJECT BOUNDARY —	
LIMIT OF WORK	
EXISTING EDGE OF PAVEMENT—	
EXISTING CONTOURS	
EXISTING SPOT ELEVATION — EXISTING A.C. PAVEMENT —	x 55.0
EXISTING A.C. PAVEMENT :	
EXISTING STORM DRAIN CLEANOUT	
EXISTING STORM DRAIN CURB.INLET	
EXISTING WATER MAIN	
EXISTING FIRE HYDRANT	
EXISTING GATE VALVE	⊗ ——
EXISTING SEWER MAIN	
EXISTING SEWER MANHOLE —	
EXISTING SEWER LATERAL	
EXISTING GAS	G F
EXISTING TELEPHONE	T
EXISTING FIRE SERVICE	FS
EXISTING STREET LIGHTS	~ \
EXISTING C.L. FENCE —	О—Х
EXISTING WOOD FENCE	
EXISTING BUILDING	
EXISTING TREES	

ARCHITECTS

1955 bacon street san diego, ca 92107 <u>e</u> 619.523.8485 a 619.523.8487 www.architects-hgw.com







revision schedule



ENGINEERING

1620 FIFTH AVENUE, SUITE 675

SAN DIEGO, CA 92101 t: 619 269-3444 | f: 619 269-3459 www.kettlerleweck.com

project

SHARP OTAY RANCH MOB

1400 E. PALOMAR STREET

CHULA VISTA, CA 91913

hgw project number 21.45

agency project number ENVIRONMENTAL: IS21-0005 DESIGN REVIEW: DR21-0029 CONDITION USE: CUP21-0019

sheet description

date

TITLE SHEET

sheet number

project phase


CITY OF CHULA VISTA


DIG ALERT NOTICE


THEY WILL NOTIFY.

IMPORTANT NOTICE

DAYS BEFORE YOU DIG.

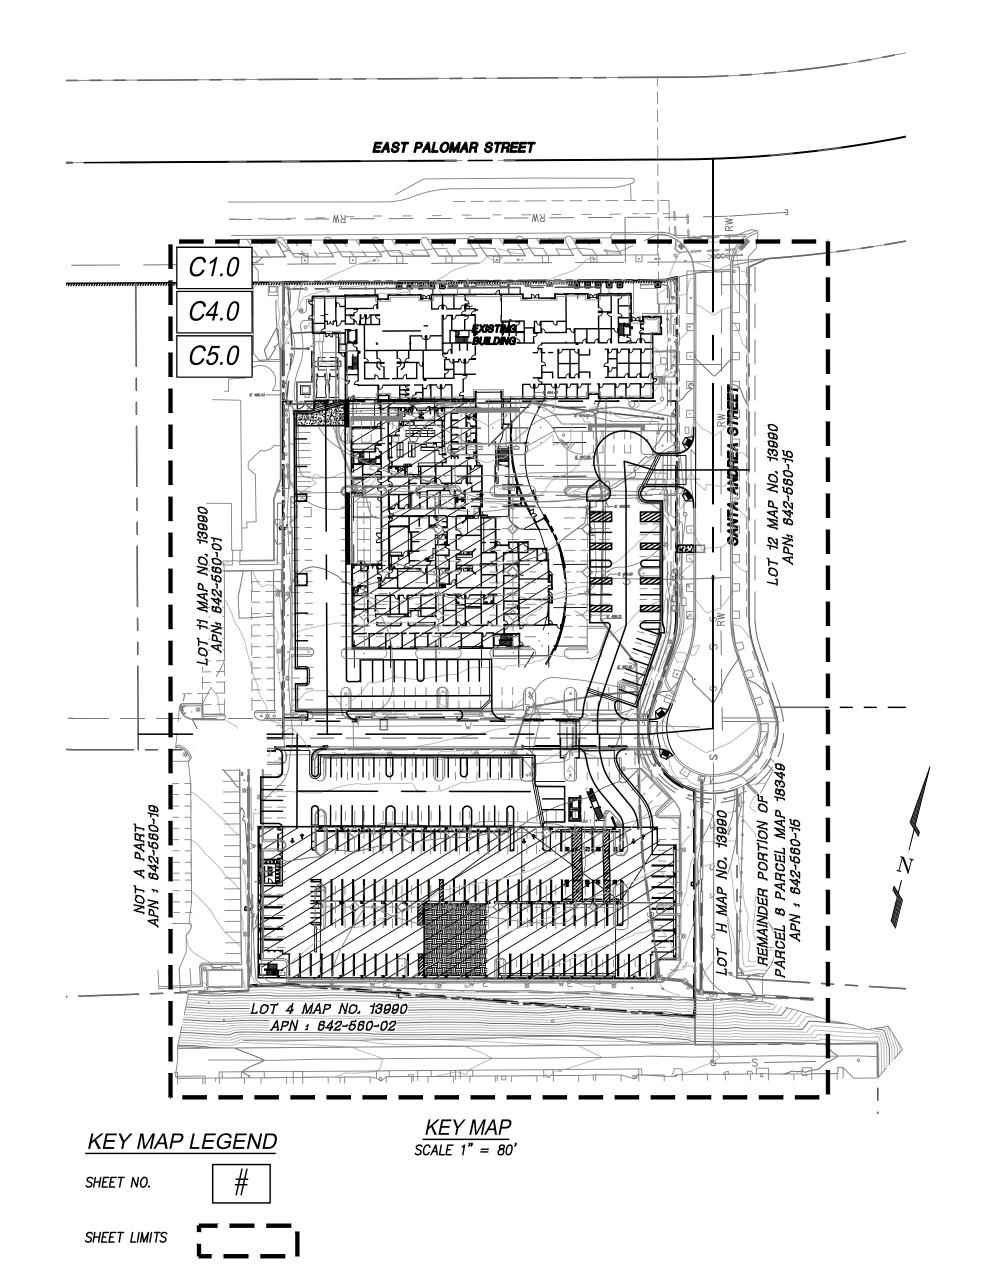


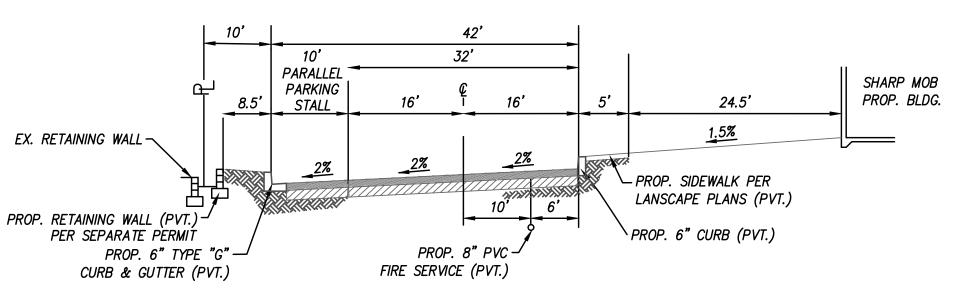

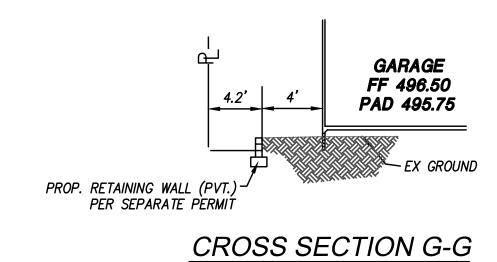


NO SCALE




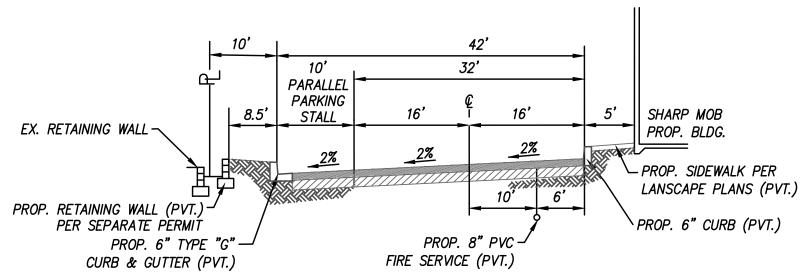


DRIVEWAY "B" - SECTION "B-B" (PVT.)

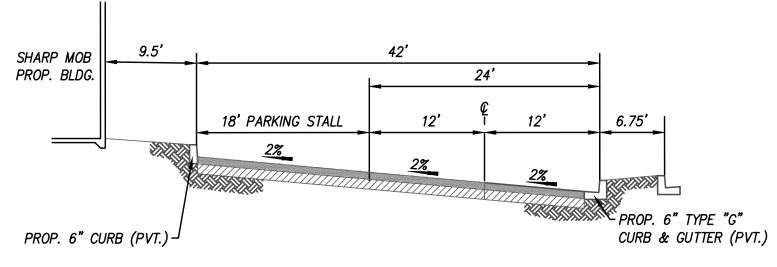


DRIVEWAY "C" - SECTION "C-C" (PVT.)

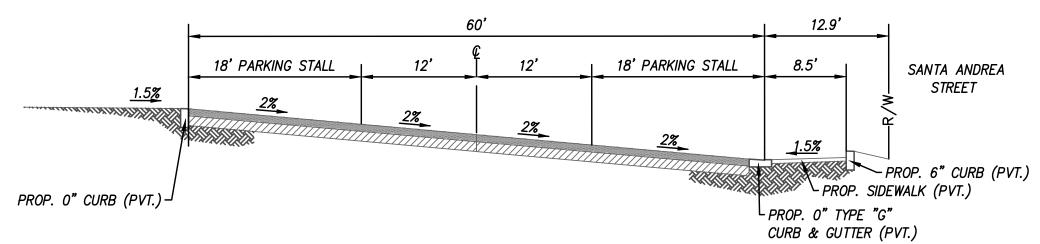

DRIVEWAY "D" - SECTION "D-D" (PVT.)

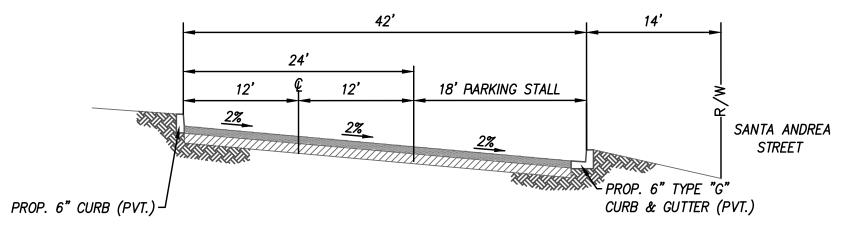

DRIVEWAY "E" - SECTION "E-E" (PVT.)
NO SCALE

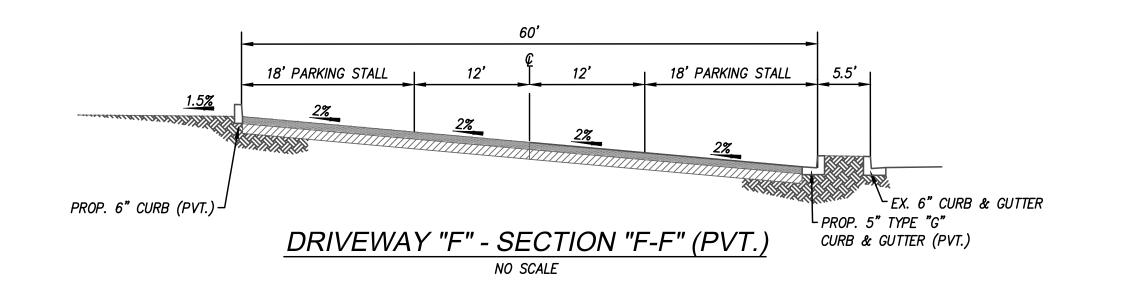



1955 bacon street san diego, ca 92107 619.523.8485 619.523.8487 www.architects-hgw.com







revision schedule

no dat

description



E N G I N E E R I N G

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www.kettlerleweck.com

project

SHARP OTAY RANCH MOB

1400 E. PALOMAR STREET CHULA VISTA, CA 91913

CONDITION USE: CUP21-0019

date	2022.06.27
hgw project number	21.45
agency project number	ENVIRONMENTAL: IS21-0005 DESIGN REVIEW: DR21-0029

sheet description


KEY MAP AND SECTIONS

sheet number

CO.1

project phase

CITY OF CHULA VISTA

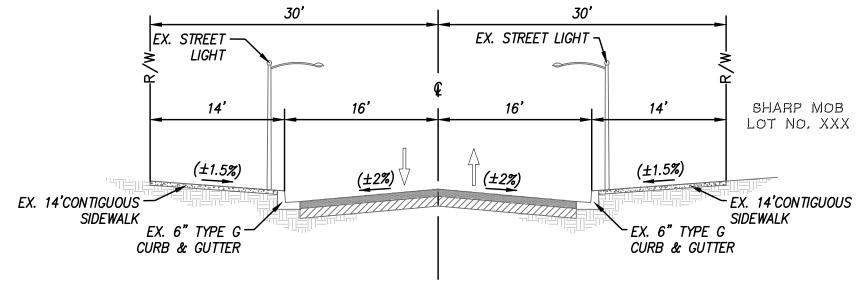

EXISTING CONDITIONS - SANTA ANDREA STREET

NO SCALE

SCALE 1:=30'

EX. SURFACE IMPROVEMENTS

1 EX. CURB TO REMOVED

2 EX. CURB AND GUTTER TO BE REMOVED

3 EX. SIDEWALK TO BE REMOVED

4 EX. ASPHALT TO BE REMOVED

5 EX. CONCRETE SLAB TO BE REMOVED

6 EX. COLUMNS TO BE REMOVED

7 EX. TREES TO BE REMOVED

8 EX. PALM TREES TO BE REMOVED

9 EX. CONCRETE STRIP TO BE REMOVED

10 EX. SIGNS TO BE REMOVED

EX. SEWER

(1) EX. 6" PVC SEWER TO REMAIN IN PLACE

(2) EX. SEWER CLEAN OUT TO REMAIN, ADJUST TO GRADE

(3) EX. 8" SEWER PER C.V. DWG NO. 99-778, TO REMAIN IN PLACE

(4) EX. MANHOLE TO REMAIN IN PLACE

EX. WATER

(1) PORTION OF EX 8" FIRE SERVICE TO BE REMOVED

(2) EX. FIRE HYDRANT TO BE RELOCATED

(3) EX. 1" AIR VALVE TO BE RELOCATED

(4) PORTION OF EX, 8" FIRE SERVICE BE REMOVED

(5) EX. 6" RECLAMED WATER PER C.V. CITY DWG NO 99-778 TO REMAIN IN PLACE.

(6) EX. 8: POTABLE WATER PER C.V. DWG. NO. 99—778 TO REMAIN IN PLACE. (7) EX. 8" FIRE SERVICE PER C.V. DWG. NO. 99-778 TO REMAIN IN PLACE.

(8) EX. FIRE HYDRANT TO REMAIN, PROTECT IN PLACE

(9) EX. WATER B.O. TO REMAIN, PROTECT IN PLACE.

EX. STORM DRAIN

1) EX. 24" RCP STORM DRAIN PIPE TO BE REMOVED.

2) EX. 18" RCP STROM DRAIN PIPE TO BE REMOVED.

 $S \setminus EX$. MOD 5' TIPE B CURB INLET TO BE REMOVED. (4) EX. TYPE B CURB INLET TO BE REMOVED.

5) PORTION OF EX. 12" PVC STORM DRAIN PIPE TO BE REMOVED.

6 EX 12" PVC STORM DRAIN PIPE TO REMAIN IN PLACE, PROTECT IN PLACE

(7) EX. 12" RCP STORM DRAIN PIPE TO BE REMOVED

(8) EX. STORM DRAIN CATCH BASIN TO REMAIN IN PLACE, ADJUST TO GRADE

(9) EX. 6" PVC STORM DRAIN TO REMAIN, PROTECT IN PLACE.

(10) EX. STORM DRAIN CLEANOUT TO REMAIN, ADJUST TO GRADE

(11) EX. STORM DRAIN CLEANOUT TO REMAIN, PROTECT IN PLACE

(12) EX. 4" PVC STORM DRAIN PIPE TO BE REMOVED

EX. DRY UTILITIES

(1) EX. STREET LIGHT TO BE REMOVED

(2) EX. ELECTRICAL BOX TO BE REMOVED

(3) EX. STREET LIGHT TO REMAIN

(4) EX. TELECOMUNICATION LINE TO BE REMOVED AND/OR RELOCATED

SCALE: 1"=30'

(5) EX. ELECTRICAL LINE TO BE REMOVED AND/OR RELOCATED

(6) EX. ELECTRICAL LINE TO REMAIN

(7) EX. GAS LINE TO BE REMOVED AND/OR RELOCATED

EX. EASEMENTS

G EXISTING PRIVATE ACCESS AND DRAINAGE EASEMENT TO CURRENT OWNERS AND/OR SUBSEQUENT OWNERS OR PURCHASES OF LOTS 1 THROUGH 12 INCLUSIVE, LOTS A, B, H, I, J, AND K AS SHOWN AND PARCEL 8 OF PACEL MAP 18349, PURSUANT TO SECTION 18.20150 OF THE CITY OF CHULA VISTA MUNICIPAL CODE RESERVED OR GRANTED ON MAP 13990. SAID EASEMENTS. SHALL BE SUBORDINATE TO ANY EXISTING EASEMENTS. ANY EASEMENTS GRANTED THEREON, AND ANY FUTURE GRANT OF EASEMENT TO THE CITY OF CHULA VISTA OR OTHER PUBLIC ENTITY.

O EXISTING PRIVATE UTILITY AND ACCESS EASEMENT TO BE RESERVED FOR THE BENEFIT OF ALL ADJACENT AND ABUTTING PROPERTY TO SAID EASEMENT INCLUDING LOTS 5, 7-11 AND NOT A PART PARCEL LYING SOUTHERLY AND ADJACENT TO SAID LOTS 7-11. SHOWN AND DEDICATED ON THE MAP FILED OR RECORDED JUNE 27, 2000 AS OF MAP NO. 13990.

26 EXISTING EASEMENT FOR LANSCAPE BUTTER, PRIVATE UTILITY, GENERAL UTILITY, ACCESS AND INDENTAL PURPOSES PER DEDICATED MAP NO. 13990, RECORDED JUNE 27, 2000 OF OFFICIAL RECORD.

27 ABUTTER'S RIGHT OF INGRESS AND EGRESS TO OR FROM EAST PALOMAR STREET HAVE BEEN DEDICATED OR RELINQUISHED ON THE MAP OF MAP NO. 13990 OF TRACT MAPS RECORDED JUNE 27, 2000.

30 EXISTING EASEMENT IN FAVOR OF OTAY WATER DISTRICT FOR UNDERGROUND WATER PIPELINES AND LATERALS, MAIN SEWER LINES, SEWER TRUNK LINES, COLLECTION LINES AND LATERALS, SEWER MANHOLES AND OTHER UNDERGROUND AND SURFACE STRUCTURES APPURTENANT TO SAID WATER AND SEWER LINES, INCLUDING BUT NOT LIMITED TO POWER LINES FOR TRANSMISION AND COMMUNICATION PURPOSES, PUMPS, REGULATORS, VALVES AND ACCESS ROADS AND INCIDENTAL PURPOSES, RECORDED AUGUST 07, 2000 AS INSTRUMENT NO. 2000-0415948 OF OFFICIAL RECORDS.

31 EXISTING EASEMENT IN FAVOR OF OTAY PROJECT L.P., A CALIFORNIA LIMITED PARTERSHIP FOR LANDSCAPE MAINTENANCE. ACCESS AND INCIDENTAL PURPOSES. RECORDED SEPTEMBER 20, 2000 AS INSTRUMENT NO. 2000-0503692 OF OFFICIAL

32 EXISTING EASEMENT IN FAVOR OF SAN DIEGO GAS AND ELECTRIC FOR THE UNDERGROUND ELECTRIC FACILITIES, AND APPURTENANCES FOR THE TRANSMISSION AND DISTRIBUTION OF ELECTRICITY. UNDERGROUND COMMINICATION FACILITES. AND APPURTENANCES. TOGETHER WITH THE RIGHT OF INGRESS THERETO AND EGRESS AND INCINDENTAL PURPOSES, RECORDED NOVEMBER 15, 2000 AS INSTRUMENT NO. 2000-0621791 OF OFFICIAL RECORDS.

33 EXISTING EASEMENT FOR THE RIGHTS OF INGRESS AND EGRESS, PRIVATE LIGHTING, MAINTENANCE AND ACCESS AND INCEDENTAL PURPOSES, RECORDED OCTOBER 23, 2001 AS INSTRUMENT IN FAVOR OF OTAY RANCH ONE COMMNITY ASSOCIATION. A CALIFORNIA NON PROFIT CORPORTATION.

34 EXISTING EASEMENT FOR THE RIGHTS OF INGRESS AND EGRESS, FOR THE CONSTRUCTION AND MAINTENANCE OF LANDSCAPING, LIGHTING AND ACCESS AND INCEDENTAL PURPOSES, RECORDED OCTOBER 23, 2001 AS INSTRUMENT IN FAVOR OF OTAY RANCH ONE COMMNITY ASSOCIATION, A CALIFORNIA NON PROFIT CORPORTATION.

ARCHITECTS hanna gabriel wells

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revision schedule



www.kettlerleweck.com

SHARP OTAY RANCH MOB

1400 E. PALOMAR STREET CHULA VISTA, CA 91913

2022.06.27 hgw project number

agency project number

ENVIRONMENTAL: IS21-0005 DESIGN REVIEW: DR21-0029 CONDITION USE: CUP21-0019

EXISTING CONDITIONS AND PARCIAL DEMOLITION PLAN

C1.0

project phase

NOTE TO CONTRACTOR:

- CONTRACTOR TO FIELD VERIFY EDGE CONDITIONS PRIOR TO START OF GRADING OPERATIONS AND PROVIDE FIELD SURVEY INFORMATION TO ENGINEER OF WORK.
- ENGINEER OF WORK TO REVIEW FIELD SURVEY INFORMATION PROVIDED BY THE CONTRACTOR AND PROVIDE CONTRACTOR WITH ANY DESIGN CHANGES, IF REQUIRED.
- STREET AND PARKING LOTS FINISHED SURFACE (FS) ELEVATIONS SHOWN ON PLAN ARE TO TOP OF PAVEMENT. CONTRACTOR SHALL
- UNDERCUT STREETS AND PARKING LOTS AS RECOMMENDED IN ACCORDANCE WITH THE APPROVED GEOTECHNICAL REPORT PREPARED
- BY LEIGHTON AND ASSOCIATES, DATED FEBRUARY 19, 2019. CONTOURS SHOWN HEREON ARE APPROXIMATE, +/-, AND FOR INFORMATION ONLY.

SCALE: 1"=20'

GRADING. STORM DRAIN AND IMPROVEMENTS NOTE:

- FOR ROUGH GRADING AND PRIVATE STORM DRAIN SEE CITY DWG NO. XXXXX
- 2. FOR STREET IMPROVEMENTS PLANS SEE DWG. NO. XXXXXXX 3. FOR PRIVATE WET UTILITY PLAN SEE SHEET C3.0

"DIG ALERT NOTICE"

SECTION 4216/4217 OF THE GOVERNMENT CODE REQUIRES THAT DIG ALERT IDENTIFICATION NUMBER BE ISSUED BEFORE A "PERMIT TO EXCAVATE" WILL BE VALID. FOR YOUR DIG ALERT 1.D. NUMBER, CALL UNDERGROUND SERVICE ALERT TOLL FREE 1-800-422-4133 AT LEAST TWO WORKING DAYS BEFORE YOU DIG.

PLAN VIEW.

SCALE 1:=20'

PROP. SURFACE IMPROVEMENTS

- 1 PROP. 6 " CURB (PVT.)
- 1A PROP. O" CURB (PVT.)
- 2 PROP. 6" CURB AND GUTTER (PVT.)
- 2A PROP. O" CURB AND GUTTER (PVT.)
- 3 PROP. STRIPING (PVT.)
- 4 PROP. 3' RIBBON GUTTER (PVT.)
- 8 PROP. 8' CROSS GUTTER PER CVSD GSI-02

ALL PAVEMENT AND GUTTERS AT ADA PARKING SPACES AND ADJACENT LOADING ZONES TO SLOPE AT 1.5% MAXIMUM.

EX. EASEMENTS

- G EXISTING PRIVATE ACCESS AND DRAINAGE EASEMENT TO CURRENT OWNERS AND/OR SUBSEQUENT OWNERS OR PURCHASES OF LOTS 1 THROUGH 12 INCLUSIVE, LOTS A, B, H, I, J, AND K AS SHOWN AND PARCEL 8 OF PACEL MAP 18349, PURSUANT TO SECTION 18.20150 OF THE CITY OF CHULA VISTA MUNICIPAL CODE RESERVED OR GRANTED ON MAP 13990. SAID EASEMENTS, SHALL BE SUBORDINATE TO ANY EXISTING EASEMENTS, ANY EASEMENTS GRANTED THEREON, AND ANY FUTURE GRANT OF EASEMENT TO THE CITY OF CHULA VISTA OR OTHER PUBLIC ENTITY.
- O EXISTING PRIVATE UTILITY AND ACCESS EASEMENT TO BE RESERVED FOR THE BENEFIT OF ALL ADJACENT AND ABUTTING PROPERTY TO SAID EASEMENT INCLUDING LOTS 5, 7-11 AND NOT A PART PARCEL LYING SOUTHERLY AND ADJACENT TO SAID LOTS 7-11. SHOWN AND DEDICATED ON THE MAP FILED OR RECORDED JUNE 27, 2000 AS OF MAP NO. 13990.
- 26 EXISTING EASEMENT FOR LANSCAPE BUTTER, PRIVATE UTILITY, GENERAL UTILITY, ACCESS AND INDENTAL PURPOSES PER DEDICATED MAP NO. 13990, RECORDED JUNE 27, 2000 OF OFFICIAL RECORD.
- 30 EXISTING EASEMENT IN FAVOR OF OTAY WATER DISTRICT FOR UNDERGROUND WATER PIPELINES AND LATERALS, MAIN SEWER LINES, SEWER TRUNK LINES, COLLECTION LINES AND LATERALS, SEWER MANHOLES AND OTHER UNDERGROUND AND SURFACE STRUCTURES APPURTENANT TO SAID WATER AND SEWER LINES, INCLUDING BUT NOT LIMITED TO POWER LINES FOR TRANSMISION AND COMMUNICATION PURPOSES, PUMPS, REGULATORS, VALVES AND ACCESS ROADS AND INCIDENTAL PURPOSES, RECORDED AUGUST 07, 2000 AS INSTRUMENT NO. 2000-0415948 OF OFFICIAL RECORDS.
- 32 EXISTING EASEMENT IN FAVOR OF SAN DIEGO GAS AND ELECTRIC FOR THE UNDERGROUND ELECTRIC FACILITIES, AND APPURTENANCES FOR THE TRANSMISSION AND DISTRIBUTION OF ELECTRICITY, UNDERGROUND COMMINICATION FACILITES, AND APPURTENANCES, TOGETHER WITH THE RIGHT OF INGRESS THERETO AND EGRESS AND INCINDENTAL PURPOSES, RECORDED NOVEMBER 15, 2000 AS INSTRUMENT NO. 2000-0621791 OF OFFICIAL RECORDS.
- 33 EXISTING EASEMENT FOR THE RIGHTS OF INGRESS AND EGRESS, PRIVATE LIGHTING, MAINTENANCE AND ACCESS AND INCEDENTAL PURPOSES, RECORDED OCTOBER 23, 2001 AS INSTRUMENT IN FAVOR OF OTAY RANCH ONE COMMNITY ASSOCIATION, A CALIFORNIA NON PROFIT CORPORTATION.
- 34 EXISTING EASEMENT FOR THE RIGHTS OF INGRESS AND EGRESS, FOR THE CONSTRUCTION AND MAINTENANCE OF LANDSCAPING, LIGHTING AND ACCESS AND INCEDENTAL PURPOSES, RECORDED OCTOBER 23, 2001 AS INSTRUMENT IN FAVOR OF OTAY RANCH ONE COMMNITY ASSOCIATION, A CALIFORNIA NON PROFIT CORPORTATION.

ARCHITECTS

hanna gabriel wells

1955 bacon street san diego, ca 92107 e 619.523.8485 £ 619.523.8487

www.architects-hgw.com

SHARP Rees-Stealy Medical Centers





revision schedule

GENERAL NOTES:

THE PROPOSED FINISH GRADING SHOWN HEREON IS PRELIMINARY ONLY AND NOT FOR

CONSTRUCTION.
2. THE EXISTING IMPROVEMENTS LOCATED ON—SITE ARE ALL PRIVATE.

DRAINAGE NOTES:

ALL PROPOSED ON-SITE DRAINAGE FACILITIES ARE PRIVATE. 2. THE PROJECT'S DEVELOPED STORM WATER RUNOFF IS CONSISTENT WITH EXISTING CONDITION (I.E. THERE IS NOT AN INCREASE IN STORM RUNOFF DUE TO THE DEVELOPMENT OF THE PROJECT).

GEOTECHNICAL NOTES

ALL GRADING MUST BE PERFORMED IN ACCORDANCE WITH APPLICABLE CITY ORDINANCE AND THE RECOMMENDATIONS AND SPECIFICATIONS SET FORTH IN THE SOILS REPORT OR

GEOLOGICAL/GEOTECHNICAL INVESTIGATION ENTITLED: 1. PRELIMINARY GEOTECHNICAL INVESTIGATION PROPOSED

GRADING INFORMATION

<u> </u>	RADING INFURIVIATION
1.	THE TOTAL SITE AREA IS 203,601 SQ-FT (4.674
2.	THE TOTAL AMOUNT OF SITE TO BE GRADED 164,858 SQ-FT (3.78 A
<i>3</i> .	THE TOTAL AMOUNT OF SITE AREA 81%
4.	THE AMOUNT OF GEOMETRIC CUT IS 300 C.Y.
<i>5</i> .	THE MAXIMUM DEPTH OF CUT IS 1 FT
<i>6</i> .	THE AMOUNT OF GEOMETRIC FILL IS 9,000 C.Y.
7.	THE MAXIMUM DEPTH OF FILL IS 4 FT
<i>8</i> .	THE MAXIMUM HEIGHT OF CUT SLOPE IS 1 FT
9.	THE MAXIMUM HEIGHT OF FILL SLOPE IS 3 FT
10.	THE MAXIMUM GRADIENT OF ALL CUT AND FILL SLOPES— 2:1
11.	THE AMOUNT OF GEOMETRIC IMPORT IS 9,000 C.Y.
12.	THE LENGTH OF PROPOSED RETAINING WALLS82 LF
13.	THE MAXIMUM HEIGHT OF PROPOSED RETAINING WALL

GRADING QUANTITY NOTES:

1. GRADING QUANTITIES ARE ESTIMATED FOR BONDING PURPOSES ONLY AND ARE NOT TO BE USED FOR PAYMENT QUANTITIES. REFER TO GEOTECHNICAL REPORT FOR FINAL REMEDIAL GRADING REQUIREMENTS (IF REQUIRED). 2. VOLUMES SHOWN ARE GEOMETRIC QUANTITIES AND EXCLUDES STREET UNDERCUTS AND

PROP. EASEMENTS

(E1) PROP. 15.5 WIDE WATER EASEMENT PER DOC. NO. XXXXXX. DATED XX/XX/XXXX.

(MEASURED FROM TW TO TF) IS---- 3 FT

SOILS REPORT----- 12,000 CY

PROP. WATER

- \$\tilde{\text{W}}\$ FOR PROP. RELOCATION OF FIRE HIDRANT SEE OTAY WATER DISTRICT PROJECT NO. XXX-XXXXXX
- (N)2) FOR PROP. NEW LOCATION OF EX. FIRE HYDRANT SEE OTAY WATER
- DISTRICT PROJECT NO. XXX-XXXXXX \$\vec{1}\sqrt{3}\text{ FOR PROP 2" WATER SERVICE SEE OTAY WATER PROJECT NO.
- XXX-XXXXXX
- \$\hat{4}\$ FOR PROP 2" WATER METER SEE OTAY WATER PROJECT NO. XXX-XXXXXX
- NS FOR PROP. 8" BACKFLOW PREVENTOR SEE OTAY WATER DISTRICT PROJECT NO. XXX-XXXXXX
- FOR PROP. 8" FIRE SERVICE SEE OTAY WATER PROJECT NO.
- XXX-XXXXXX \$\tilde{N}\$ FOR PROP 2" WATER SERVICE SEE OTAY WATER PROJECT NO.
- (NB) FOR PROP 6" FIRE SERVICE SEE OTAY WATER PROJECT NO. XXX-XXXXXX



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SHARP OTAY RANCH MOB

1400 E. PALOMAR STREET CHULA VISTA, CA 91913

CONDITION USE: CUP21-0019

date 2022.06.27 hgw project number 21.45 ENVIRONMENTAL: IS21-0005 agency project number DESIGN REVIEW: DR21-0029

sheet description

GRADING PLAN

sheet number

project phase

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revision schedule



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SHARP OTAY RANCH MOB

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ENVIRONMENTAL: IS21-0005 DESIGN REVIEW: DR21-0029 CONDITION USE: CUP21-0019

21.45

sheet description


GRADING PLAN

sheet number

project phase

CITY OF CHULA VISTA

MATCHLINE SEE SHEET G2.0

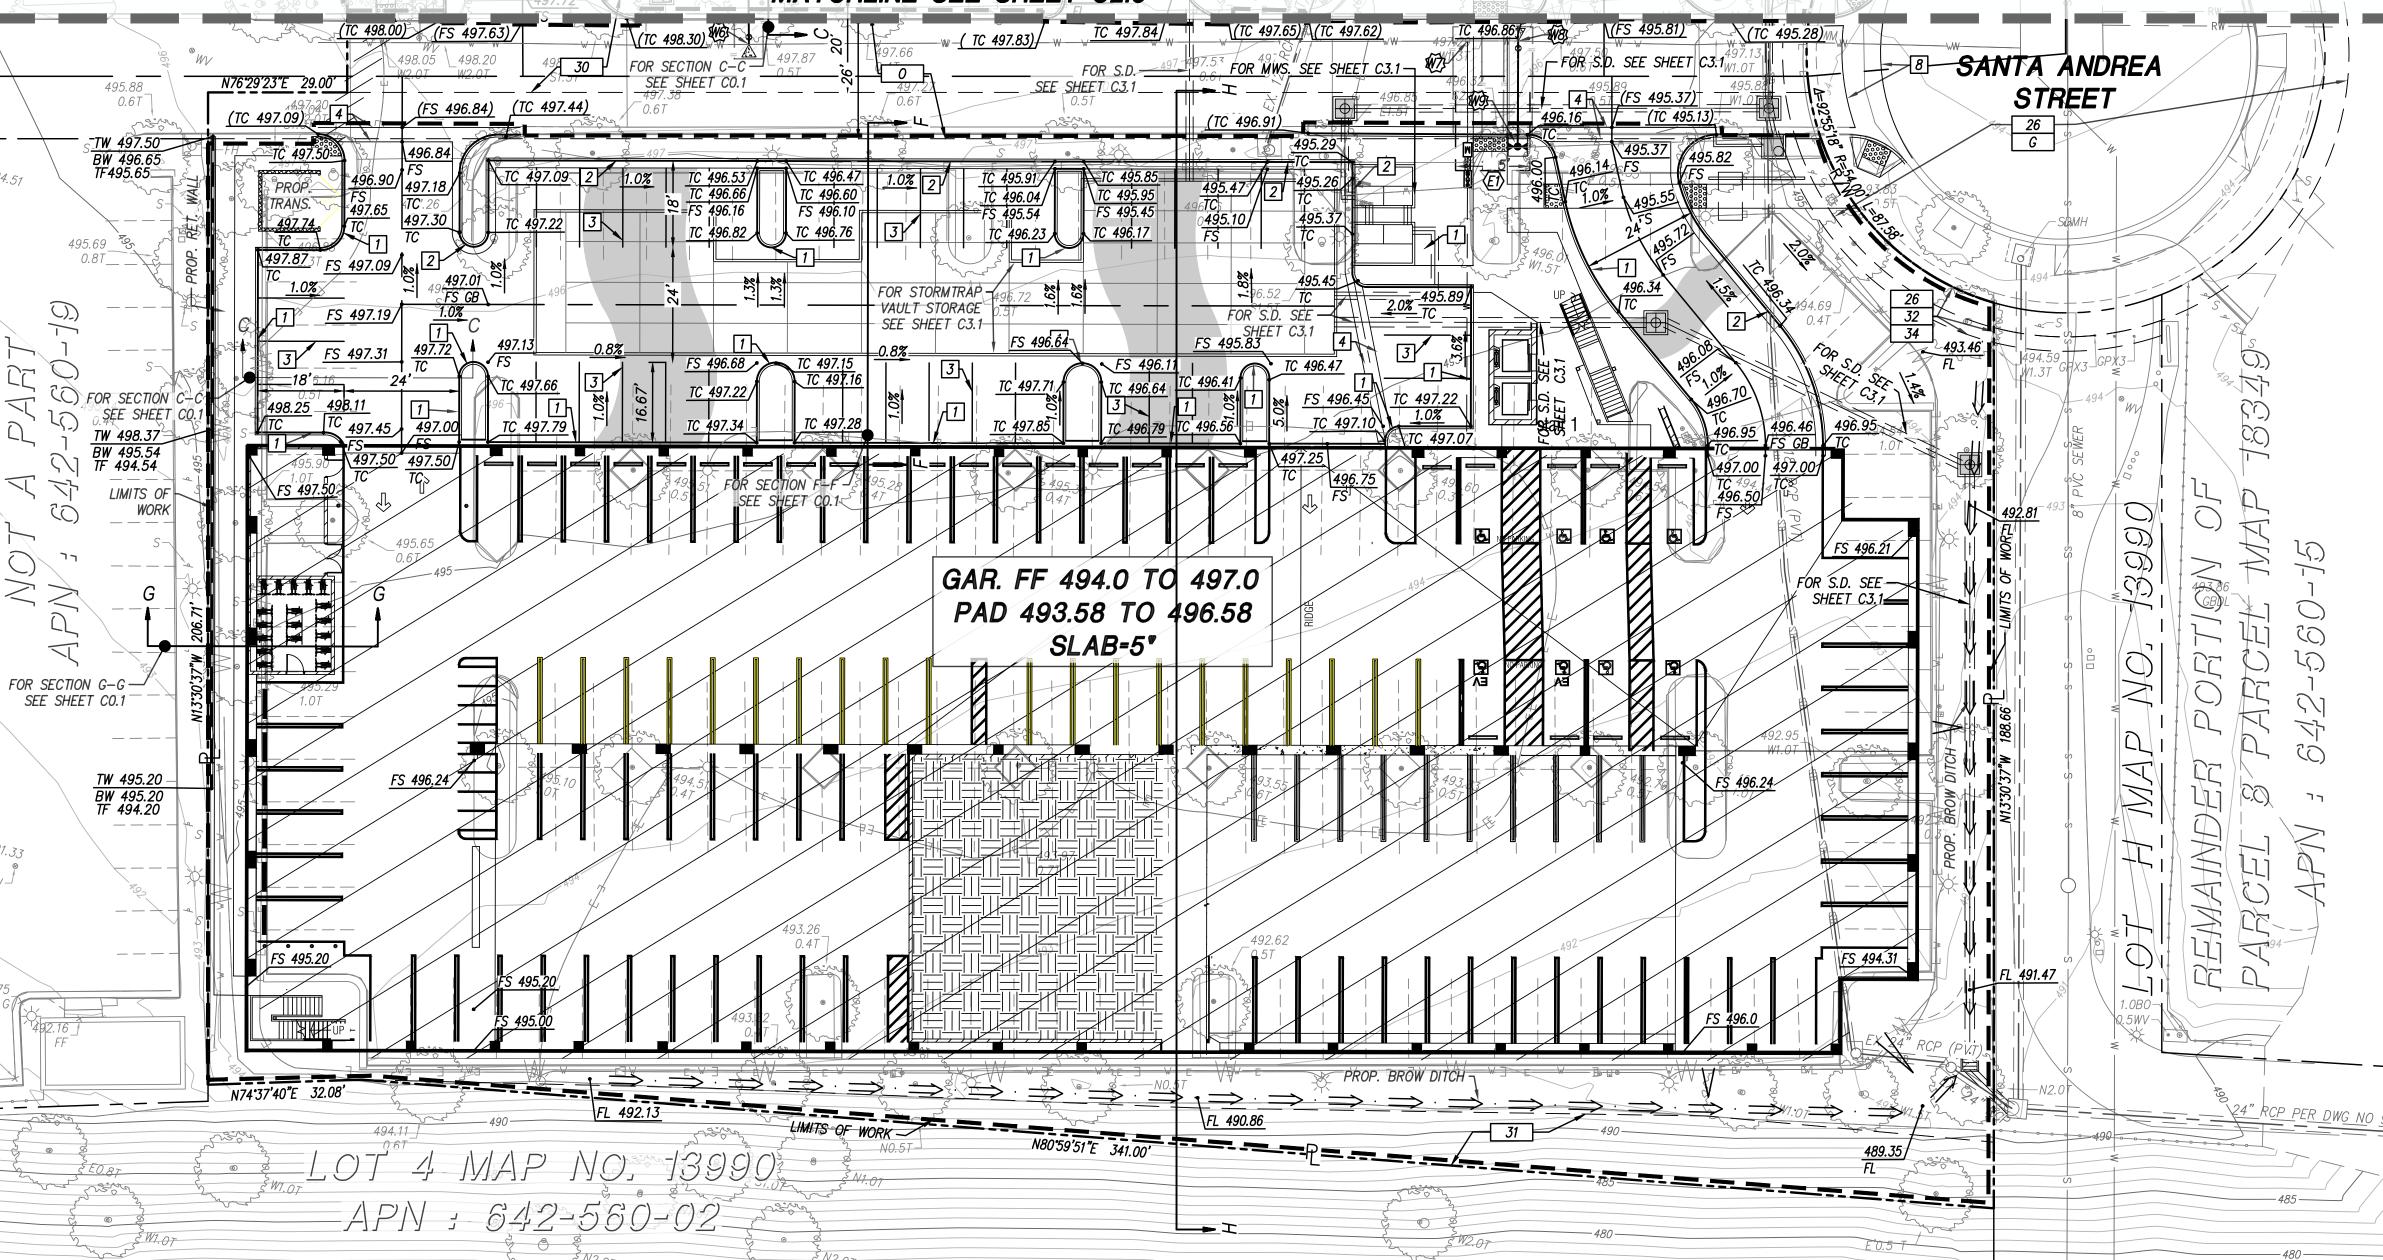

PROP. SURFACE IMPROVEMENTS

1 PROP. 6 " CURB (PVT.)

2 PROP. 6" CURB AND GUTTER (PVT.)

3 PROP. STRIPING (PVT.)

4 PROP. 3' RIBBON GUTTER (PVT.)

8 PROP. 8' CROSS GUTTER PER CVSD GSI-02

NOTE TO CONTRACTOR:

CONTRACTOR TO FIELD VERIFY EDGE CONDITIONS PRIOR TO START OF GRADING OPERATIONS AND PROVIDE FIELD SURVEY INFORMATION TO ENGINEER OF WORK.

ENGINEER OF WORK TO REVIEW FIELD SURVEY INFORMATION PROVIDED BY THE CONTRACTOR AND PROVIDE


CONTRACTOR WITH ANY DESIGN CHANGES, IF REQUIRED. STREET AND PARKING LOTS FINISHED SURFACE (FS) ELEVATIONS SHOWN ON PLAN ARE TO TOP OF PAVEMENT. CONTRACTOR SHALL UNDERCUT STRÈETS AND PARKING LOTS AS RECOMMENDED IN ACCORDANCE WITH THE APPROVED GEOTECHNICAL REPORT PREPARED BY LEIGHTON AND ASSOCIATES, DATED FEBRUARY 19.

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GRADING. STORM DRAIN AND IMPROVEMENTS NOTE:

1. FOR ROUGH GRADING AND PRIVATE STORM DRAIN SEE CITY DWG NO. XXXXX 2. FOR STREET IMPROVEMENTS PLANS SEE DWG. NO. XXXXXX

3. FOR PRIVATE WET UTILITY PLAN SEE SHEET C3.0

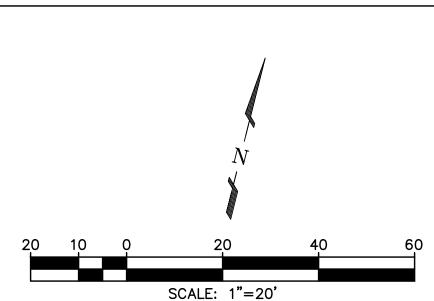

EX. EASEMENTS

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PLAN VIEW.

SCALE 1:=20'

30 EXISTING EASEMENT IN FAVOR OF OTAY WATER DISTRICT FOR UNDERGROUND WATER PIPELINES AND LATERALS, MAIN SEWER LINES, SEWER TRUNK LINES, COLLECTION LINES AND LATERALS, SEWER MANHOLES AND OTHER UNDERGROUND AND SURFACE STRUCTURES APPURTENANT TO SAID WATER AND SEWER LINES, INCLUDING BUT NOT LIMITED TO POWER LINES FOR TRANSMISION AND COMMUNICATION PURPOSES, PUMPS, REGULATORS, VALVES AND ACCESS ROADS AND INCIDENTAL PURPOSES, RECORDED AUGUST 07, 2000 AS INSTRUMENT NO. 2000-0415948 OF OFFICIAL RECORDS.

31 EXISTING EASEMENT IN FAVOR OF OTAY PROJECT L.P., A CALIFORNIA LIMITED PARTERSHIP FOR LANDSCAPE MAINTENANCE, ACCESS AND INCIDENTAL PURPOSES, RECORDED SEPTEMBER 20, 2000 AS INSTRUMENT NO. 2000-0503692 OF OFFICIAL RECORDS.

32 EXISTING EASEMENT IN FAVOR OF SAN DIEGO GAS AND ELECTRIC FOR THE UNDERGROUND ELECTRIC FACILITIES, AND APPURTENANCES FOR THE TRANSMISSION AND DISTRIBUTION OF ELECTRICITY, UNDERGROUND COMMINICATION FACILITES, AND APPURTENANCES, TOGETHER WITH THE RIGHT OF INGRESS THERETO AND EGRESS AND INCINDENTAL PURPOSES, RECORDED NOVEMBER 15, 2000 AS INSTRUMENT NO. 2000-0621791 OF OFFICIAL RECORDS.

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PROP. EASEMENTS

(E1) PROP. 15.5 WIDE WATER EASEMENT PER DOC. NO. XXXXXX. DATED XX/XX/XXXX.

PROP. WATER


\$\tilde{\mathbb{N}} FOR PROP. 8" BACKFLOW PREVENTOR SEE OTAY WATER DISTRICT PROJECT NO. XXX-XXXXXX

WE FOR PROP. 8" FIRE SERVICE SEE OTAY WATER PROJECT NO. XXX-XXXXXX

(WT): FOR PROP 2" WATER SERVICE SEE OTAY WATER PROJECT NO. XXX—XXXXXX

WE FOR PROP 6" FIRE SERVICE SEE OTAY WATER PROJECT NO. XXX-XXXXXX

WY FOR PROP FIRE HYDRANT SEE OTAY WATER PROJECT NO. XXX-XXXXX

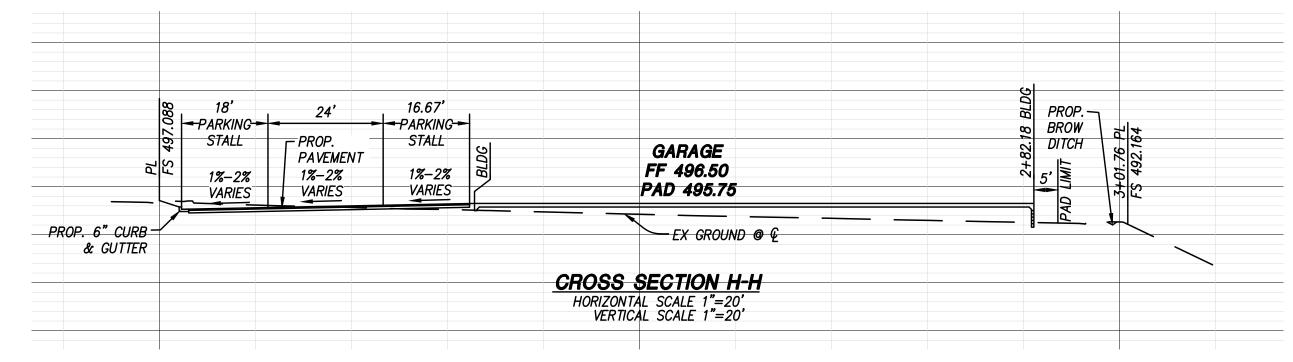

ALL PAVEMENT AND GUTTERS AT ADA PARKING SPACES AND ADJACENT LOADING ZONES TO SLOPE AT 1.5% MAXIMUM.

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revision schedule

- PROJECT NO. XXX-XXXXXX
- (NZ) FOR PROP. NEW LOCATION OF EX. FIRE HYDRANT SEE OTAY WATER DISTRICT PROJECT NO. XXX-XXXXXX
- \$\text{W3}\$ FOR PROP 2" WATER SERVICE SEE OTAY WATER PROJECT NO.
- ₩4 FOR PROP 2" WATER METER SEE OTAY WATER PROJECT NO. XXX-XXXXXX \$\sqrt{9}\$ FOR PROP. 8" BACKFLOW PREVENTOR SEE OTAY WATER DISTRICT PROJECT
- FOR PROP. 8" FIRE SERVICE SEE OTAY WATER PROJECT NO. XXX-XXXXXX \$\tilde{\pi}\text{7} FOR PROP 2" WATER SERVICE SEE OTAY WATER PROJECT NO.
- WAS FOR PROP 6" FIRE SERVICE SEE OTAY WATER PROJECT NO. XXX-XXXXXX FOR PROP FIRE HYDRANT SEE OTAY WATER PROJECT NO. XXX-XXXXXX

	PRIVATE WATER DATA				
(NO)	BEARING/DELTA	RADIUS	LENGTH	NOTE	
W1	N 76°38'51" E		100.98'	2" PVC	

PRIVATE FIRE SERVICE DATA					
(N)	BEARING/DELTA	RADIUS	LENGTH	NOTE	
F1	N 12°35'27" W		7.66'	2" PVC	
F2	N 13°47'56" W		10.43'	2" PVC	
F3	N 76°12'04" E		21.05'	2" PVC	
F4	N 13°48'34" W		106.77	2" PVC	
F5	N 58°29'24" W	-	7.13'	2" PVC	
F6	N 76°18'15" E		23.49'	2" PVC	
F7	N 58°41'45" W		7.07'	2" PVC	
F8	N 13°41'45" W		12.00'	2" PVC	
F9	N 58°41'45" W		7.07'	2" PVC	

	PRIVATE SEWER LATERAL DATA				I <i>TA</i>
₩(>	BEARING/DELTA	RADIUS	LENGTH	NOTE
S	1	N 76°38'51" E		44.20'	8" PVC

NOTE: ALL PRIVATE STORM DRAIN PER CITY OF CHULA VISTA DDWG. NO. XXXXXX

No. C48358 \ Exp. 6−30−2024 / KETTLER LEWECK

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SHARP OTAY RANCH MOB

1400 E. PALOMAR STREET CHULA VISTA, CA 91913

CONDITION USE: CUP21-0019

date	2022.06.27
hgw project number	21.45
agency project number	ENVIRONMENTAL: IS21-0005 DESIGN REVIEW: DR21-0029

sheet description STORM DRAIN AND UTILITIES PLAN

sheet number

project phase

CITY OF CHULA VISTA

PLAN VIEW SCALE 1:=20'

GRADING. STORM DRAIN AND IMPROVEMENTS NOTE.

1. FOR ROUGH GRADING AND PRIVATE STORM DRAIN SEE CITY DWG NO. XXXXX 2. FOR STREET IMPROVEMENTS PLANS SEE DWG. NO. XXXXXX

"DIG ALERT NOTICE"

PROP. STORM DRAIN

C.V. DWG NO XXXXX

(SD1) STORM DRAIN CLEANOUT (PVT)

(SD2) STORM DRAIN TYPE A-4 CO (PVT)

\$D4 STORM DRAIN CURB INLET (PVT)

SD5 24'X24' CATCH BASIN BROOKS BOX (PVT.)

(SD7) MODULAR WETLAND SYSTEM MWS-L8-12-6'9"-C (PVT.) SEE CITY OF

SCALE: 1"=20'

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EX. EASEMENTS

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PROP. EASEMENTS (E1) PROP. 15.5 WIDE WATER EASEMENT PER DOC. NO. XXXXXX. DATED XX/XX/XXXX.

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LOTS 7-11. SHOWN AND DEDICATED ON THE MAP FILED OR RECORDED JUNE 27, 2000 AS OF MAP NO. 13990.

DEDICATED MAP NO. 13990, RECORDED JUNE 27, 2000 OF OFFICIAL RECORD.

AUGUST 07, 2000 AS INSTRUMENT NO. 2000-0415948 OF OFFICIAL RECORDS.

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ONE COMMNITY ASSOCIATION, A CALIFORNIA NON PROFIT CORPORTATION.

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revision schedule



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SHARP OTAY RANCH MOB

1400 E. PALOMAR STREET CHULA VISTA, CA 91913

е	2022.06.27
v project number	21.45

ENVIRONMENTAL: IS21-0005 agency project number

DESIGN REVIEW: DR21-0029 CONDITION USE: CUP21-0019

sheet description

STORM DRAIN AND UTILITIES PLAN

sheet number

project phase

CITY OF CHULA VISTA

MATCHLINE SEE SHEET C3.0 SANTA ANDREA STREET


FOR GRADING SEE SHEET C2.1 9 GAR. FF 494.0 TO 497.0 7AR7 560 PAD 493.58 TO 496.58 SLAB=5" 人が N74°37′40″E 32.08′ CONNECT TO EX. S.D. CO. -PER DWG NO. 99-473

> PLAN VIEW SCALE 1:=20'

GRADING. STORM DRAIN AND IMPROVEMENTS NOTE:

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- 30 EXISTING EASEMENT IN FAVOR OF OTAY WATER DISTRICT FOR UNDERGROUND WATER PIPELINES AND LATERALS, MAIN SEWER LINES, SEWER TRUNK LINES, COLLECTION LINES AND LATERALS, SEWER MANHOLES AND OTHER UNDERGROUND AND SURFACE STRUCTURES APPURTENANT TO SAID WATER AND SEWER LINES, INCLUDING BUT NOT LIMITED TO POWER LINES FOR TRANSMISION AND COMMUNICATION PURPOSES, PUMPS, REGULATORS, VALVES AND ACCESS ROADS AND INCIDENTAL PURPOSES, RECORDED AUGUST 07, 2000 AS INSTRUMENT NO. 2000-0415948 OF OFFICIAL RECORDS.
- 31 EXISTING EASEMENT IN FAVOR OF OTAY PROJECT L.P., A CALIFORNIA LIMITED PARTERSHIP FOR LANDSCAPE MAINTENANCE, ACCESS AND INCIDENTAL PURPOSES. RECORDED SEPTEMBER 20, 2000 AS INSTRUMENT NO. 2000-0503692 OF OFFICIAL RECORDS.
- 32 EXISTING EASEMENT IN FAVOR OF SAN DIEGO GAS AND ELECTRIC FOR THE UNDERGROUND ELECTRIC FACILITIES, AND APPURTENANCES FOR THE TRANSMISSION AND DISTRIBUTION OF ELECTRICITY, UNDERGROUND COMMINICATION FACILITES, AND APPURTENANCES, TOGETHER WITH THE RIGHT OF INGRESS THERETO AND EGRESS AND INCINDENTAL PURPOSES, RECORDED
- 34 EXISTING EASEMENT FOR THE RIGHTS OF INGRESS AND EGRESS, FOR THE CONSTRUCTION AND MAINTENANCE OF LANDSCAPING, LIGHTING AND ACCESS AND INCEDENTAL PURPOSES, RECORDED OCTOBER 23, 2001 AS INSTRUMENT IN FAVOR OF OTAY RANCH ONE COMMNITY ASSOCIATION, A CALIFORNIA NON PROFIT CORPORTATION.

PRIVATE FIRE SERVICE DATA					
W	BEARING/DELTA	RADIUS	LENGTH	NOTE	
F1	N 13°35'13" W		3.00'	8" PVC	
F2	N 58°40'01" W		<i>5.63</i> ′	8" PVC	
F3	N 13°07'58" W		<i>54.26</i> ′	8" PVC	

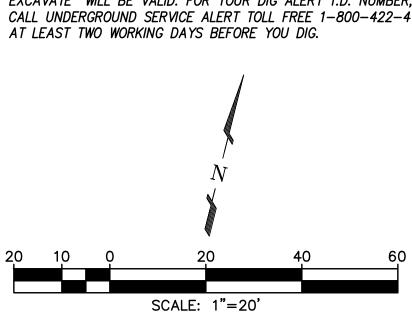NOTE: ALL PRIVATE STORM DRAIN PER CITY OF CHULA VISTA DDWG. NO. XXXXXX

PROP. WATER


\$\overline{\pi}\$ FOR PROP. 8" BACKFLOW PREVENTOR SEE OTAY WATER DISTRICT PROJECT NO.


XXX-XXXXXX WG FOR PROP. 8" FIRE SERVICE SEE OTAY WATER PROJECT NO. XXX-XXXXXX \$\tilde{N}\$ FOR PROP 2" WATER SERVICE SEE OTAY WATER PROJECT NO. XXX-XXXXXX \$\text{\$\text{\$\text{\$\text{\$}}}\$} FOR PROP 6" FIRE SERVICE SEE OTAY WATER PROJECT NO. XXX-XXXXXX MYS FOR PROP FIRE HYDRANT SEE OTAY WATER PROJECT NO. XXX-XXXXXX

PROP. STORM DRAIN

SD2 STORM DRAIN TYPE A-4 CO (PVT)

- \$D4 STORM DRAIN CURB INLET (PVT)
- SD7 MODULAR WETLAND SYSTEM MWS-L8-12-6'9"-C (PVT.) SEE CITY OF C.V. DWG NO
- SD8 MODULAR WETLAND SYSTEM MWS-L-8-12-10'-2"-C-HC (PVT.) SEE CITY OF C.V.
- SD9 MODULAR WETLAND SYSTEM MWS-L-8-12-5'-0"-V-UG-HC (PVT.) SEE CITY OF C.V.
- SD10 EX. STORM DRAIN CLEANOUT PLER CITY DWG. NO. 99-743-D

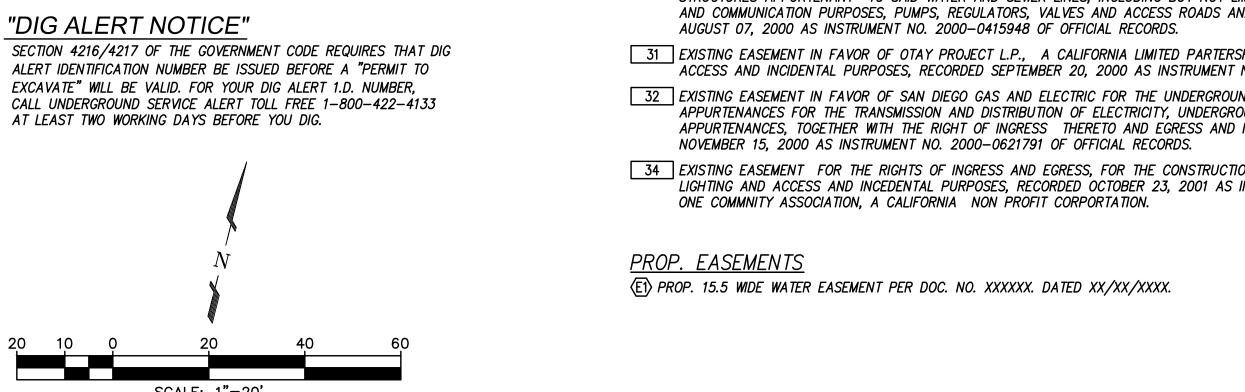

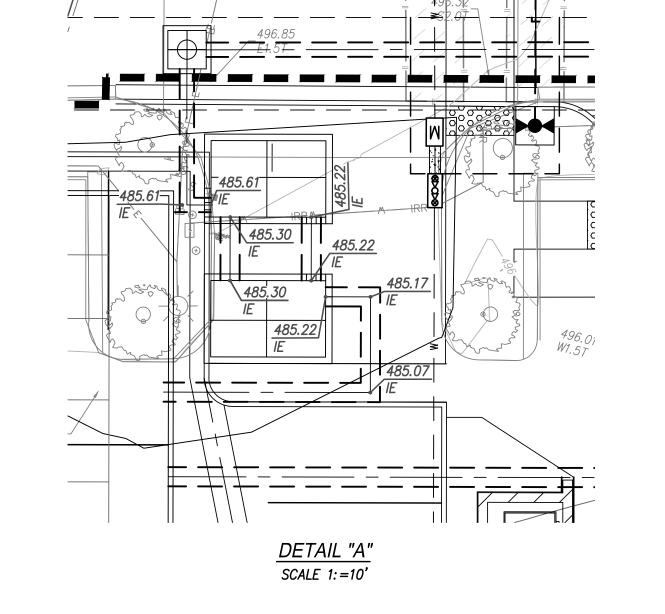

(140' EXISTING LEFT TURN LANE)

O EXISTING PRIVATE UTILITY AND ACCESS EASEMENT TO BE RESERVED FOR THE BENEFIT OF ALL ADJACENT AND ABUTTING PROPERTY TO SAID EASEMENT INCLUDING LOTS 5, 7-11 AND NOT A PART PARCEL LYING SOUTHERLY AND ADJACENT TO SAID LOTS 7-11. SHOWN AND

26 EXISTING EASEMENT FOR LANSCAPE BUTTER, PRIVATE UTILITY, GENERAL UTILITY, ACCESS AND INDENTAL PURPOSES PER DEDICATED MAP NO. 13990, RECORDED JUNE 27, 2000 OF

27 ABUTTER'S RIGHT OF INGRESS AND EGRESS TO OR FROM EAST PALOMAR STREET HAVE BEEN DEDICATED OR RELINQUISHED ON THE MAP OF MAP NO. 13990 OF TRACT MAPS RECORDED

30 EXISTING EASEMENT IN FAVOR OF OTAY WATER DISTRICT FOR UNDERGROUND WATER PIPELINES AND LATERALS, MAIN SEWER LINES, SEWER TRUNK LINES, COLLECTION LINES AND LATERALS, SEWER MANHOLES AND OTHER UNDERGROUND AND SURFACE STRUCTURES APPURTENANT TO SAID WATER AND SEWER LINES, INCLUDING BUT NOT LIMITED TO POWER LINES FOR TRANSMISION AND COMMUNICATION PURPOSES, PUMPS, REGULATORS, VALVES AND ACCESS ROADS AND INCIDENTAL PURPOSES, RECORDED AUGUST 07, 2000 AS INSTRUMENT NO. 2000-0415948 OF OFFICIAL RECORDS.

31 EXISTING EASEMENT IN FAVOR OF OTAY PROJECT L.P., A CALIFORNIA LIMITED PARTERSHIP FOR LANDSCAPE MAINTENANCE, ACCESS AND INCIDENTAL PURPOSES, RECORDED SEPTEMBER 20, 2000 AS INSTRUMENT NO. 2000-0503692 OF OFFICIAL RECORDS.

32 EXISTING EASEMENT IN FAVOR OF SAN DIEGO GAS AND ELECTRIC FOR THE UNDERGROUND ELECTRIC FACILITIES, AND APPURTENANCES FOR THE TRANSMISSION AND DISTRIBUTION OF ELECTRICITY. UNDERGROUND COMMINICATION FACILITES, AND APPURTENANCES, TOGETHER WITH THE RIGHT OF INGRESS THERETO AND EGRESS AND INCINDENTAL PURPOSES, RECORDED NOVEMBER 15, 2000 AS INSTRUMENT NO. 2000-0621791 OF OFFICIAL RECORDS.

33 EXISTING EASEMENT FOR THE RIGHTS OF INGRESS AND EGRESS, PRIVATE LIGHTING, MAINTENANCE AND ACCESS AND INCEDENTAL PURPOSES, RECORDED OCTOBER 23, 2001 AS INSTRUMENT IN FAVOR OF OTAY RANCH ONE COMMNITY ASSOCIATION, A CALIFORNIA NON PROFIT CORPORTATION.

34 EXISTING EASEMENT FOR THE RIGHTS OF INGRESS AND EGRESS, FOR THE CONSTRUCTION AND MAINTENANCE OF LANDSCAPING, LIGHTING AND ACCESS AND INCEDENTAL PURPOSES, RECORDED OCTOBER 23, 2001 AS INSTRUMENT IN FAVOR OF OTAY RANCH ONE COMMNITY ASSOCIATION, A CALIFORNIA NON PROFIT CORPORTATION.

PROP. EASEMENTS

(E1) PROP. 15.5 WIDE WATER EASEMENT PER DOC. NO. XXXXXX. DATED XX/XX/XXXX.

LEGEND

PROPERTY BOUNDARY

6" CURB (PVT) PER SDRSD G-1

DIAGONAL STRIPE (NO PARKING) PER SDRSD M-27A

6" CURB AND GUTTER (PVT) PER SDRSD G-2

PLANTED AREA (PVT) PER LANDSCAPE PLAN

RETAINING WALL PER CITY DWG NO. XXXXXX

PAVEMENT SECTIONS

RECOMMENDATION OF SOILS ENGINEER

PARKING (PVT) PER LANDSCAPE PLAN

FIRE TRUCK ACCESS/DRIVE AISLE


PARKING STALLS

ENHANCED WALKWAYS. SEE LANDSCAPE PLANS FOR

DETAILS. WALKWAYS SHALL BE 4" PCC REINFORCED

WALKWAYS

PROP 4" PARKING STALL STRIPING (PVT) (19-LF MIN. UNLESS OTHERWISE NOTED)

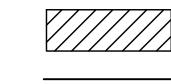

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1955 bacon street

san diego, ca 92107 e 619.523.8485


a 619.523.8487



ARCHITECTS

hanna gabriel wells



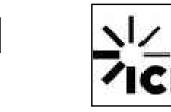

revision schedule

FIRE ACCESS PAVEMENT SECTION PER SOILS ENGINEER RECOMMENDATION (4" AC OVER 11" CL. II AGGREGATE PROP. 250' LEFT TURN LANE 120' PROP REVERSE CURVE



GRAPHIC SCALE



KETTLER & LEWECK

E N G I N E E R I N G 1620 FIFTH AVENUE, SUITE 675 SAN DIEGO, CA 92101 t: 619 269-3444 | f: 619 269-3459 www.kettlerleweck.com

SHARP OTAY RANCH MOB

1400 E. PALOMAR STREET CHULA VISTA, CA 91913

2022.06.27 hgw project number agency project number

ENVIRONMENTAL: IS21-0005 DESIGN REVIEW: DR21-0029 CONDITION USE: CUP21-0019

HORIZONTAL CONTROL/SURFACE IMPROVEMENTS PLAN

project phase

CITY OF CHULA VISTA

PROP. SURFACE IMPROVEMENTS

1 PROP. 6 " CURB (PVT.)

1A PROP. O" CURB (PVT.)

2 PROP. 6" CURB AND GUTTER (PVT.)

4 PROP. 3' RIBBON GUTTER (PVT.) 5 PROP. TRUNCATED DOMES (PVT) PER CVSD GSI-08


6 PROP SIDEWALK/WALKWAY (PVT.) PER LANDSCAPE PLAN

7 PROP. CURB RAMP WITH TRUNCATED DOME (PVT.) PER CVSD GSI-08

8 PROP. 8' CROSS GUTTER PER CVSD GSI-02


9 CONCRETE PAVEMENT

10 INCREASE THE TURN BAY STORAGE FOR THE LEFT TURN TO 250' (CONSISTENT WITH CVSD

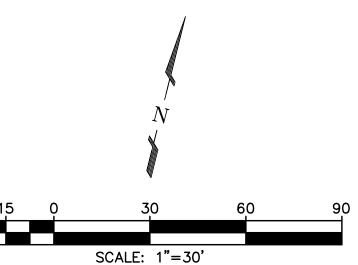

"DIG ALERT NOTICE"

SECTION 4216/4217 OF THE GOVERNMENT CODE REQUIRES THAT DIG ALERT IDENTIFICATION NUMBER BE ISSUED BEFORE A "PERMIT TO EXCAVATE" WILL BE VALID. FOR YOUR DIG ALERT 1.D. NUMBER, CALL UNDERGROUND SERVICE ALERT TOLL FREE 1-800-422-4133 AT LEAST TWO WORKING DAYS BEFORE YOU DIG.

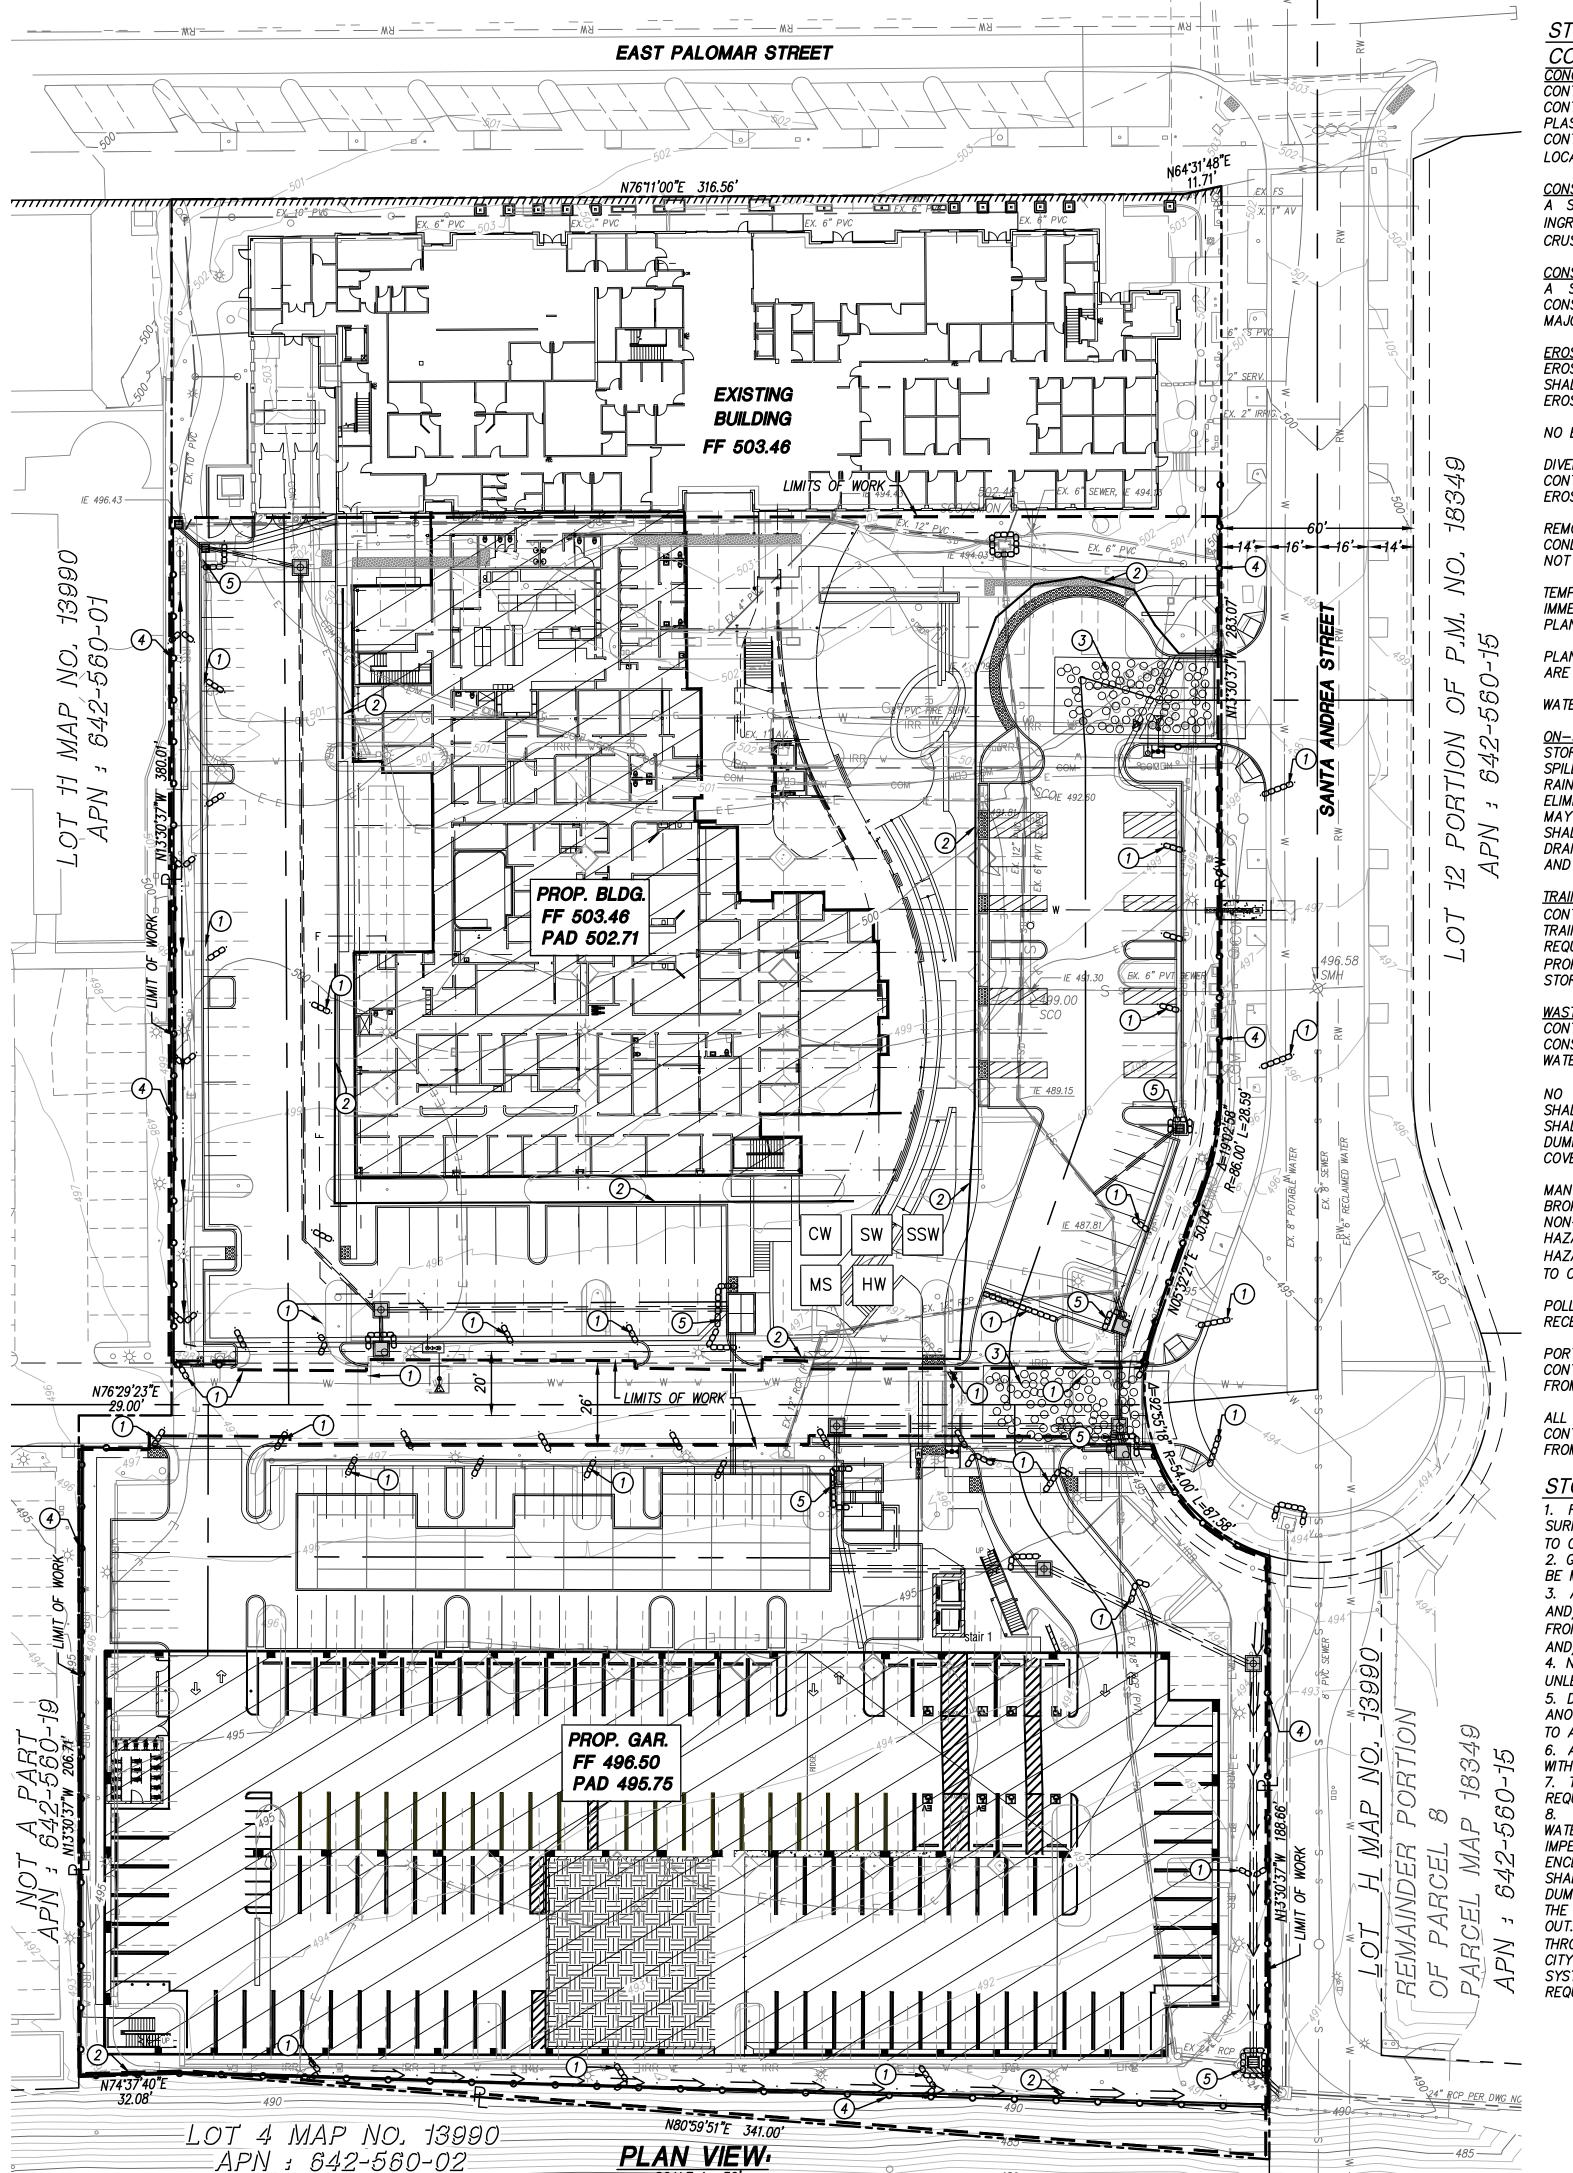

STORMWATER POLLUTION CONTROL BMP NOTES RELATIVE TO CONSTRUCTION ACTIVITIES

CONCRETE WASHOUT

CONTRACTOR SHALL ESTABLISH AND USE AN ADEQUATELY SIZED CONCRETE WASHOUT AREA TO CONTAIN WASHOUT WASTES ON SITE. IT IS ILLEGAL TO WASH CONCRETE, SLURRY, MORTAR, STUCCO, PLASTER AND THE LIKE INTO THE STORMWATER CONVEYANCE SYSTEM OR ANY RECEIVING WATER. CONTRACTOR SHALL POST A SIGN DESIGNATING THE WASHOUT LOCATION. CONCRETE WASHOUT LOCATION TO BE PLACED IN AN AREA NOT DESIGNATED FOR FUTURE PLANTING/LANDSCAPING AREA.

CONSTRUCTION SITE ACCESS
A STABILIZED CONSTRUCTION SITE ACCESS SHALL BE PROVIDED FOR VEHICLES EGRESS AND INGRESS TO PREVENT TRACKING DIRT OFF SITE. THIS SHALL INCLUDE USING MATERIAL SUCH AS 3" CRUSHED ROCK AND/OR CORRUGATED STEEL PANELS/PLATES.

CONSTRUCTION VEHICLES

A SPECIFIC AREA AWAY FROM GUTTERS AND STORM DRAIN SHALL BE DESIGNATED FOR CONSTRUCTION VEHICLES PARKING, VEHICLE REFUELING, AND ROUTINE EQUIPMENT MAINTENANCE. ALL MAJOR REPAIRS SHALL BE MADE OFF-SITE.

EROSION CONTROL MUST BE PROVIDED FOR ALL EROSIVE SURFACES. SLOPED SURFACES ESPECIALLY SHALL BE PROTECTED AGAINST EROSION BY INSTALLING EROSION RESISTANT SURFACES SUCH AS EROSION CONTROL MATS, ADEQUATE GROUND COVER VEGETATION, AND BONDED FIBER MATRIX.

NO EXCAVATION AND GRADING ACTIVITIES ARE ALLOWED DURING WET WEATHER.

DIVERSION DIKES SHALL BE CONSTRUCTED TO CHANNEL RUNOFF AROUND THE CONSTRUCTION SITE. CONTRACTOR SHALL PROTECT CHANNELS AGAINST EROSION USING PERMANENT AND TEMPORARY EROSION CONTROL MEASURES.

REMOVE EXISTING VEGETATION ONLY WHEN ABSOLUTELY NECESSARY. LARGE PROJECTS SHALL BE CONDUCTED IN PHASES TO AVOID UNNECESSARY REMOVAL OF THE NATURAL GROUND COVER. DO NOT REMOVE TREES OR SHRUBS UNNECESSARILY; THEY HELP DECREASE EROSION.

TEMPORARY VEGETATION MUST BE PLANTED ON SLOPES OR WHERE CONSTRUCTION IS NOT IMMEDIATELY PLANNED FOR EROSION CONTROL PURPOSES. EROSION SHALL BE PREVENTED BY PLANTING FAST-GROWING ANNUAL AND PERENNIAL GRASSES TO SHIELD AND BIND THE SOIL.

PLANT PERMANENT VEGETATION AS SOON AS POSSIBLE, ONCE EXCAVATION AND GRADING ACTIVITIES ARE COMPLETE.

WATER USAGE FOR DUST CONTROL SHALL BE MINIMIZED.

ON-SITE CONSTRUCTION MATERIAL STORAGE

STORED MATERIALS SHALL BE CONTAINED IN A SECURE PLACE TO PREVENT SEEPAGE AND SPILLAGE. CONTRACTOR SHALL STORE THESE PRODUCTS WHERE THEY WILL STAY DRY OUT OF THE RAIN. CONTRACTOR SHALL PROVIDE SECONDARY CONTAINMENT FOR ALL FUEL STORED ON-SITE. ELIMINATE OR REDUCE POLLUTION OF STORMWATER FROM STOCKPILES KEPT ON-SITE. STOCKPILES MAY INCLUDE SOIL, PARING MATERIALS, ASPHALT CONCRETE, AGGREGATE BASE, ETC. STOCKPILES SHALL BE LOCATED AWAY FROM CONCENTRATED STORMWATER STORMWATER FLOWS AND STORM DRAIN INLETS. STOCKPILES SHALL BE COVERED OR PROTECTED WITH SOIL STABILIZATION MEASURES AND PROVIDED WITH A TEMPORARY SEDIMENT BARRIER AROUND THE PERIMETER AT ALL TIMES.

CONTRACTORS' EMPLOYEES WHO PERFORM CONSTRUCTION IN THE CITY OF CHULA VISTA SHALL BE TRAINED TO BE FAMILIAR WITH THE CITY OF CHULA VISTA STORMWATER POLLUTION CONTROL REQUIREMENTS. THESE BMP NOTES SHALL BE AVAILABLE TO EVERYONE WORKING ON SITE. THE PROPERTY OWNER(S) AND THE PRIME CONTRACTOR MUST INFORM SUBCONTRACTORS ABOUT STORMWATER REQUIREMENTS AND THEIR OWN RESPONSIBILITIES.

CONTRACTOR SHALL BE RESPONSIBLE FOR PROPERLY DISPOSING OF ALL WASTE AND UNUSED CONSTRUCTION MATERIALS. DUMPING OF UNUSED OR WASTE PRODUCTS ON THE GROUND, WHERE WATER CAN CARRY THEM INTO THE CONVEYANCE SYSTEM IS STRICTLY PROHIBITED.

NO SEEPAGE FROM ANY DUMPSTER SHALL BE DISCHARGED INTO STORMWATER. BERMS/DIKES SHALL BE PLACED AROUND ALL DUMPSTERS TO DIVERT THE NATURAL STORM RUNOFF. DUMPSITES SHALL BE CHECKED FREQUENTLY FOR LEAKS. DUMPSTER LIDS SHALL REMAIN CLOSED AT ALL TIMES. DUMPSTERS WITHOUT LIDS SHALL BE PLACED WITHIN STRUCTURES WITH IMPERVIOUS ROOFING OR COVERED WITH TARPS IN ORDER TO AVOID RAIN CONTACT WITH ANY TRASH MATERIAL.

MANY CONSTRUCTION MATERIALS, INCLUDING SOLVENTS, WATER-BASED PAINTS, VEHICLE FLUIDS, BROKEN ASPHALT AND CONCRETE, WOOD, AND CLEARED VEGETATION CAN BE RECYCLED. NON-RECYCLABLE MATERIALS MUST BE TAKEN TO AN APPROPRIATE LANDFILL OR DISPOSED OF AS HAZARDOUS WASTE. FOR INFORMATION ON DISPOSAL OF HAZARDOUS MATERIAL, CALL THE HAZARDOUS WASTE HOTLINE TOLL FREE AT (800) 714-1195. FOR INFORMATION ON LANDFILLS AND TO ORDER DUMPSTERS CALL EDCO AT (760) 436-4151.

POLLUTANTS SHALL BE KEPT OFF EXPOSED SURFACES. PLACE TRASH CANS AND RECYCLING RECEPTACLES AROUND THE SITE.

PORTABLE TOILETS MUST BE IN GOOD WORKING ORDER AND CHECKED FREQUENTLY FOR LEAKS. CONTRACTOR SHALL PROVIDE SECONDARY CONTAINMENT AND LOCATE PORTABLE TOILETS AWAY FROM STORMDRAIN INLETS ON PERVIOUS SURFACES.

ALL CONSTRUCTION DEBRIS SHALL BE KEPT AWAY FROM THE STREET, GUTTER, AND STORMDRAIN. CONTRACTOR MUST ROUTINELY CHECK AND CLEAN UP MATERIAL THAT MAY HAVE TRAVELED AWAY FROM CONSTRUCTION SITE.

STORMWATER POLLUTION CONTROL POST CONSTRUCTION BMP NOTES 1. FOR STORM WATER POLLUTION CONTROL PURPOSES, ALL RUNOFF FROM ALL IMPERVIOUS

SURFACES INCLUDING ROOF DRAINS SHALL DISCHARGE ONTO GRASS AND LANDSCAPE AREAS PRIOR TO COLLECTION AND DISCHARGE ONTO THE STREET AND/OR INTO THE PUBLIC STORM DRAIN SYSTEM. 2. GRASS AND LANDSCAPE AREAS DESIGNATED FOR STORM WATER POLLUTION CONTROL SHALL NOT BE MODIFIED WITHOUT APPROVAL OF THE DSA INSPECTOR.

3. ALL IMPERVIOUS AREAS WITHIN THE SITE SHALL DRAIN TO APPROVED BMP/IMP FACILITIES AND/OR TO TURF OR LANDSCAPED AREAS WITH ADEQUATE GROUNDCOVER PRIOR TO DISCHARGE FROM THE SITE. ALL IMPERVIOUS AREAS MUST SLOPE TOWARD THE APPROVED BMP/IMP FACILITY AND/OR THE TURF/LANDSCAPED AREAS.

4. NO DRAINS SHALL BE INSTALLED IN HARDSCAPE, DRIVEWAYS, OR ANY OTHER IMPERVIOUS AREA UNLESS THE FLOW FROM THE DRAIN DISCHARGES TO AN ADEQUATE IMP/BMP. 5. DRIVEWAYS SHALL HAVE A MINIMUM 2% CROSS SLOPE TOWARD THE IMP/BMP AREA OR HAVE

ANOTHER APPROVED DRAINAGE SYSTEM THAT IS DESIGNED TO COLLECT RUNOFF AND DISCHARGE IT TO AN ADEQUATE IMP/BMP. 6. ALL STORMWATER IMP/BMP FACILITIES SHOWN HEREON SHALL NOT BE MODIFIED OR ALTERED

WITHOUT APPROVAL OF THE DSA INSPECTOR. 7. THE INSTALLATION OF ADDITIONAL IMPERVIOUS SURFACES NOT SHOWN ON THIS PLAN MAY

REQUIRE THAT THIS PLAN BE REVISED OR THAT A SEPARATE ENGINEERING PERMIT BE OBTAINED. 8. ALL EXISTING AND PROPOSED TRASH ENCLOSURES SHALL BE FITTED TO COMPLY WITH STORM WATER BEST MANAGEMENT PRACTICE REQUIREMENTS. THE TRASH ENCLOSURES SHALL HAVE AN IMPERVIOUS, NON-COMBUSTIBLE ROOF THAT WILL NOT ALLOW RAIN WATER TO ENTER THE ENCLOSURE. THE ENCLOSURE SHALL BE LOCKABLE AND LOCKED WHEN NOT IN USE. A BERM SHALL BE INSTALLED AT ALL OPENINGS TO HOLD IN ANY LIQUIDS THAT ESCAPE FROM THE DUMPSTER AND TO PREVENT ANY FLOW OF STORM WATER THROUGH THE TRASH ENCLOSURE AREA. THE BERM CAN BE CONSTRUCTED WIDE AND FLAT TO ALLOW ROLLING OF THE DUMPSTER IN AND OUT. THE ENCLOSURE SHALL BE SELF CONTAINED OR MAY HAVE A DRAIN THAT DISCHARGES THROUGH AN ADEQUATELY SIZED OIL/ GREASE SEPARATOR AND IS THEN FILTERED THROUGH A CITY-APPROVED HYDROCARBON FILTÉR AND DISCHARGED INTO THE PUBLIC SANITARY SEWER SYSTEM, NOT TO PLANTERS OR THE STORM DRAIN SYSTEM. A SEPARATE BUILDING PERMIT MAY BE REQUIRED FOR THIS STRUCTURE.

LEGEND

STABILIZED CONSTRUCTION ENTRANCE

TEMPORARY GRAVEL BAGS

SOLID WASTE STORAGE (SW)

MATERIAL STORAGE (MS)

HAZARDOUS WASTE (SSW)

CONCRETE WASTE STORAGE (CW)


SANITARY SEWER WASTE STORAGE (SSW)

<u>ITEM</u>	<u>SYMBOL</u>
OJECT BOUNDARY AND OR RIGHT OF WAY	
STING RIGHT-OF-WAY	R/W
AINAGE FLOW	→ → -
	000000000000000000000000000000000000000

19	755 bacon street
san	diego, ca 92107
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Ä	619.523.8487
www.arc	nitects-hgw.com

ARCHITECTS

ORARY SILT FENCE	
ORARY FIBER FOLL	
ORARY INLET PROTECTION · · · · · · · · · · · · · · · · · · ·	

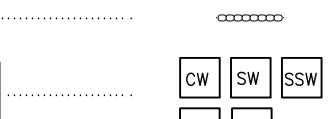




HARP Rees-Stealy Medical Center

PROP CONSTRUCTION NOTES (PVT. EROSION CONTROL)

- (1) INSTALL GRAVEL BAGS (SEE DETAIL IN SHEET C5.1)
- (2) INSTALL FIBER ROLL (SEE DETAIL IN SHEET C5.1) (3) CONSTRUCTION STABILIZATION ENTRANCE/EXIT (SEE DETAIL IN SHEET C5.1)
- (4) INSTALL SILT FENCE (SEE DETAIL IN SHEET C5.1)
- (5) INSTALL INLET PROTECTION (SEE DETAIL IN SHEET C5.1)



revision schedule

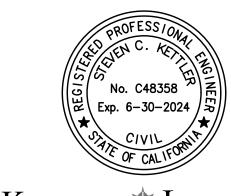

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www.kettlerleweck.com

SHARP OTAY RANCH MOB

1400 E. PALOMAR STREET CHULA VISTA, CA 91913

date 2022.06.27 hgw project number 21.45 agency project number ENVIRONMENTAL: IS21-0005

DESIGN REVIEW: DR21-0029 CONDITION USE: CUP21-0019


sheet description


EROSION CONTROL PLAN

sheet number


C5.0

project phase

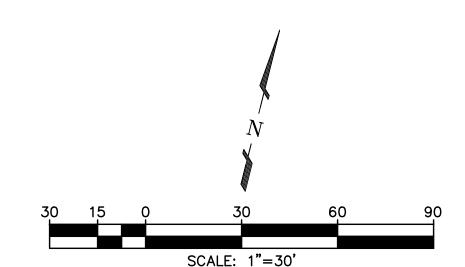

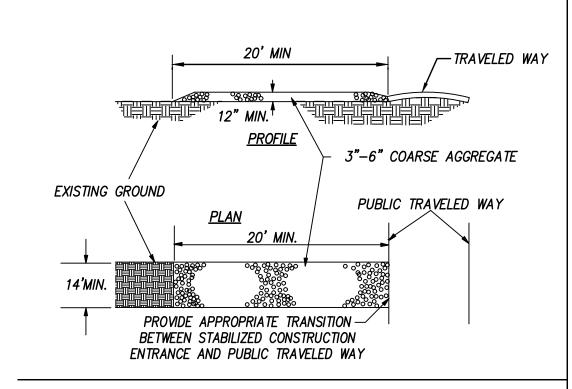


STABILIZED CONSTRUCTION ENTRANCE

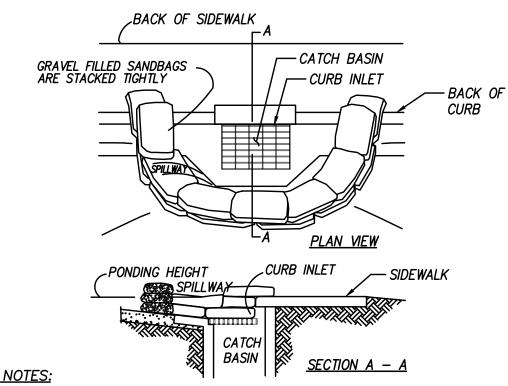


1. PLACE CURB TYPE SEDIMENT BARRIERS ON GENTLY SLOPING STREET
SEGMENTS WHERE WATER CAN POND AND ALLOW SEDIMENT TO SEPARATE
FROM RUNOFF.

- SANDBAGS, OF EITHER BURLAP OR WOVEN GEOTEXTILE FABRIC, ARE FILLED WITH GRAVEL, LAYERED AND PACKED TIGHTLY.
 LEAVE ONE SANDBAG GAP IN THE TOP ROW TO PROVIDE A SPILLWAY FOR
- 4. INSPECT BARRIERS AND REMOVE SEDIMENT AFTER EACH STORM EVENT. SEDIMENT AND GRAVEL MUST BE REMOVED FROM THE TRAVELED WAY IMMEDIATELY.

GRAVEL BAG INLET PROTECTION

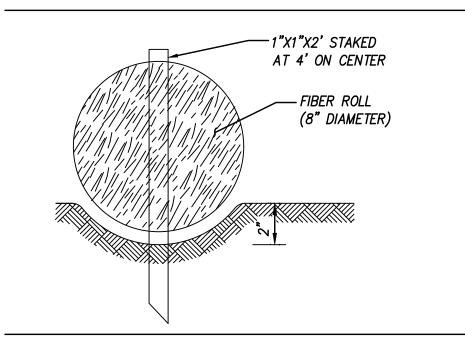

FIBER ROLL

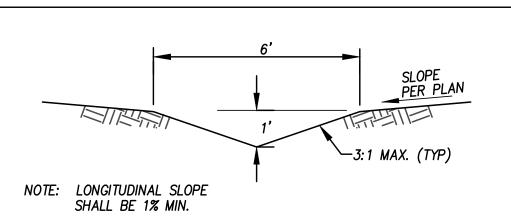

EARTHEN SWALE DETAIL (PVT)

HYDROSEED APPLICATION PROCEDURES:

1. SEED MIXES SHALL BE SPECIFIED BY THE PURE LIVE SEED OF EACH SPECIES.

-OPENING AT INLET

2 BAGS HIGH

_, @ LOW POINT

-EMBED FIRST ROW

OF GRAVEL BAGS

HALF DEPTH

TYPICAL INLET DETAIL

3 FT MIN.

THREE LAYERS OF GRAVEL BAGS WITH ENDS OVERLAPPED

2. STAPLE WIRE FENCING TO

4. BACKFILL AND COMPACT THE

PREFABRICATED SILT FENCE MAYBE USED IN LIEU OF IN PLACE CONSTRUCTION.

EXCAVATED SOIL.

FILTER FABRIC —

THE POSTS.

-EMBED FIRST ROW

BAG EMBEDDING DETAIL

GRAVEL BAG DETAILS NOT TO SCALE

GRAVEL

BAGGING ON

BIORETENTION

SWALE

OF GRAVEL BAGS

HALF DEPTH

GRAVEL

BAGGING ON

PARKING LOT

RUNOFF

GRAVEL BAGS

GAP BETWEEN BAGS ACTS AS SPILLWAY

1. SET POSTS AND EXCAVATE A

FROM AND ALONG THE LINE OF

4 BY 4 IN TRENCH UPSLOPE

3. ATTACH THE FILTER FABRIC TO THE WIRE FENCE AND EXTEND IT INTO THE TRENCH.

SILT FENCE NTS

GRAVEL BAGS OVERLAP ONTO CURB

2. FIBER MULCH SHALL BE APPLIED AT A MINIMUM RATE OF 2,000 POUNDS PER ACRE EXCEPT WHEN USED IN CONJUNCTION WITH STRAW MULCH, WHEN IT SHALL BE APPLIED AT A MINIMUM RATE OF 400 POUNDS PER ACRE.

3. A WETTING AGENT CONSISTING OF 95 PERCENT ALKYL POLYETHYLENE GLYCOL ETHER SHALL BE APPLIED AS PER MANUFACTURERS' RECOMMENDATIONS.

4. EQUIPMENT USED FOR THE APPLICATION OF SLURRY SHALL HAVE A BUILT—IN AGITATION SYSTEM TO SUSPEND AND HOMOGENEOUSLY MIX THE SLURRY. THE SLURRY MIX SHALL BE DYED GREEN. THE EQUIPMENT MUST HAVE A PUMP CAPABLE OF APPLYING SLURRY UNIFORMLY.

5. GRADED, DISTURBED, OR ERODED AREAS TO BE TREATED WITH A NON-IRRIGATED HYDROSEED MIX SHALL RECEIVE AN INTERIM BINDER/TACKIFIER AS NEEDED BETWEEN APRIL 2 AND AUGUST 31 FOR DUST-EROSION CONTROL WITH SUBSEQUENT APPLICATION OF HYDROSEED MIX DURING THE RAINY SEASON BETWEEN OCTOBER 1 AND APRIL 1.

NON-IRRIGATED HYDROSEED MIX:

	COASTAL SAGE SCRUB WITH I	<u>BASIC NATIVE ER</u>	OSION CONTROL
<u>SPECIES</u>	<u>COMMON NAME</u>	BULK #S/ACRE	MIN % PLS*
ACMISPON AMERICANUS	PURSHING LOTUS	1.00	74
ACMISPON GLABER	DEERWEED	3.00	81
ARTEMISIA CALIFORNICA	CALIFORNIA SAGEBRUSH	1.00	18
CAMISSONIOPSIS CHEIRANT	THIFOLIA BEACH EVENING PRIMRO	OSE 0.50	<i>86</i>
COLLINSIA HETEROPHYLLA	CHINESE HOUSES	1.00	<i>83</i>
ENCELIA CALIFORNICA	BUSH SUNFLOWER	2.00	21
ERIOGONUM FASCICULATUN	A CALIFORNIA BUCKWHEAT	4.00	10
ESCHSCHOLZIA CALIFORNIC	CA CALIFORNIA POPPY	1.00	<i>83</i>
FESTUCA MICROSTACHYS	SMALL FESCUE	10.00	90
ISOCOMA MENZIESII	COAST GOLDENBUSH	1.00	10
LASTHENIA CALIFORNICA	DWARF GOLDFIELDS	0.50	<i>68</i>
LUPINUS SUCCULENTUS	ARROYO LUPINE	1.00	<i>83</i>
MIMULUS AURANTIACUS PL	UNICEUS MISSION RED MONKEYFLO	OWER 1.00	3
SALVIA APIANA	WHITE SAGE	1.00	<i>3</i> 5
SALVIA MELLIFERA	BLACK SAGE	1.00	60
SISYRINCHIUM BELLUM	BLUE-EYED GRASS	1.00	<i>78</i>
STIPA PULCHRA	PURPLE NEEDLE GRASS	3.00	<i>73</i>
BROMUS CARINATUS CUCA	AMONGA'	15.00	
TRIFOLIUM CILIOLATUM		4.00	

*NOTE: PLS LBS/ACRE = LBS/ACRE. PLS LBS/ACRE IS THE MOST ACCURATE WAY TO SPECIFY SEEDS AND TAKES INTO ACCOUNT BOTH PURITY AND GERMINATION. PLS % = % PURITY X % GERMINATION.

FOR APPLICATION PROCEDURES SEE NOTE RIGHT.

AT THE COMPLETION OF THE WORK SHOWN, THE
FOLLOWING PLAN SHALL BE FOLLOWED TO ENSURE
WATER QUALITY CONTROL IS MAINTAINED FOR THE LIFE
OF THE PROJECT:

1. STABILIZATION: ALL PLANTED SLOPES AND OTHER VEGETATED AREAS SHALL BE INSPECTED PRIOR TO OCTOBER 1 OF EACH YEAR AND AFTER MAJOR RAINFALL EVENTS (MORE THAN 1/2 INCH) AND REPAIRED AND REPLANTED AS NEEDED UNTIL A NOTICE OF TERMINATION (NOT) IS FILED.

2. STRUCTURAL PRACTICES: DESILTING BASINS, DIVERSION DITCHES, DOWNDRAINS, INLETS, OUTLET, PROTECTION MEASURES, AND OTHER PERMANENT WATER QUALITY AND SEGMENT AND EROSION CONTROLS SHALL BE INSPECTED PRIOR TO OCTOBER 1ST OF EACH YEAR AND AFTER MAJOR RAINFALL EVENTS (MORE THAN 1/2 INCH). REPAIRS AND REPLACEMENTS SHALL BE MADE AS NEEDED AND RECORDED IN THE MAINTENANCE LOG IN PERPETUITY.

A R C H I T E C T S hanna gabriel wells

1955 bacon street san diego, ca 92107 619.523.8485 a 619.523.8487 www.architects-hgw.com





revision schedule

no. date

description



E N G I N E E R I N G 1620 FIFTH AVENUE, SUITE 675 SAN DIEGO, CA 92101 t: 619 269-3444 | f: 619 269-3459 www.kettlerleweck.com

project

SHARP OTAY RANCH MOB

1400 E. PALOMAR STREET CHULA VISTA, CA 91913

CONDITION USE: CUP21-0019

date	2022.06.27
hgw project number	21.45
agency project number	ENVIRONMENTAL: IS21-0005 DESIGN REVIEW: DR21-0029

sheet description

EROSION CONTROL
DETAILS PLAN

sheet number

C5.1

project phase

FIRE TRUCK ACCESS PLAN



CHULA VISTA FIRE DEPARTMENT

FIRE PREVENTION DIVISION

AUTO TURN DATA: Ladder Truck
This design apparatus, along with data points, shall be used as the basis for roadway and parking lot geometrics.


• Outside Track Width: 111" (9' 3")
• Inside Track: 82" (6' 10")
• Lock to Lock Time: 6.0 seconds
• Angle of Departure: 7° (max)
• Angle of Departure: 7° (max)

Notes:


SCALE: 1"=30'

- 1. A Chula Vista Fire Department Maneuverability Analysis shall be performed by a licensed professional engineer to verify the turning capabilities of this design apparatus. Travel paths should begin outside the site illustrating the turn onto all entry roads/drives, maneuvering around the site, and completed with an illustration demonstrating exiting from the site.
- 2. Paths must illustrate the full vehicle swept path (including wheel tracks and wall-to-wall vehicle overhang sweep) and must indicate a clear, unobstructed travel around the site without impact/collisions to buildings, curbs, landscaping, parking spaces, vehicles, etc. Wheel tracks shall not come within 1 foot of curbs. Apparatus bumper overhang shall not extend over curbs and the like.
- 3. Design speed (no less than 5mph); if speed varies indicate points of change by notes/labels.
- 4. The Chula Vista Fire Department Maneuverability Analysis shall be used to create an exhibit, which shall be submitted for review and approval.
- Maneuverability Analysis shall also be designed to and confirm that any angle of approach/departure does not exceed 7°.
- 6. This detail shall be reproduced on the submitted exhibit.

CHULA VISTA FIRE DEPARTMENT • Fire Prevention Division • 276 Fourth Avenue, Building C • Chula Vista, CA 91910 (619) 691-5029 • fax (619) 691-5204 • www.chulavistaca.gov/goto/FirePrevention

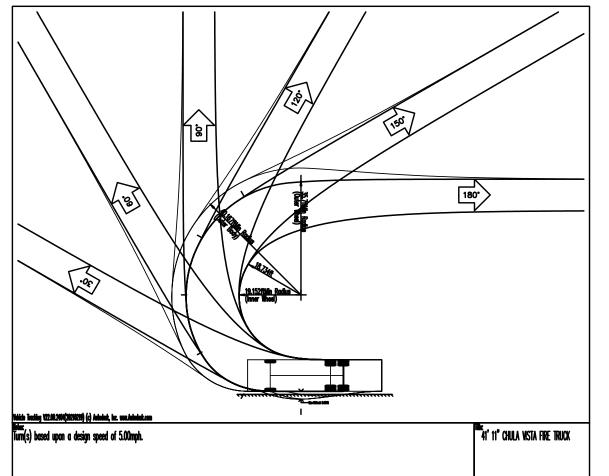

FIRE TRUCK DETAILS

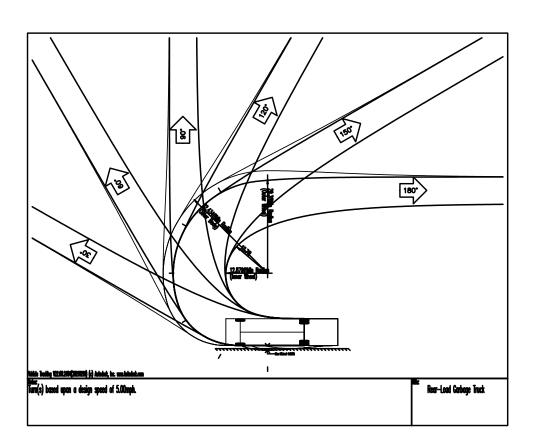

WASTE/RECYCLING TRUCK DETAILS



ENGINEERING

ENGINEERING

1620 FIFTH AVENUE, SUITE 675
SAN DIEGO, CA 92101
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SHARP OTAY RANCH MOB

1400 E. PALOMAR STREET CHULA VISTA, CA 91913 2022.06.27

hgw project number

21.45

agency project number

ENVIRONMENTAL: IS21-0005
DESIGN REVIEW: DR21-0029
CONDITION USE: CUP21-0019

sheet description

FIRE AND WASTE/RECYCLING
TRUCK ACCESS PLAN

sheet number

C6.0

project phase

CITY OF CHULA VISTA



ARCHITECTS

SHARP Rees-Stealy Medical Centers

CONSTRUCTION

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hanna gabriel wells

revision schedule