
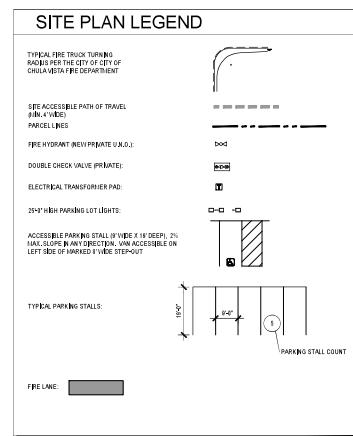
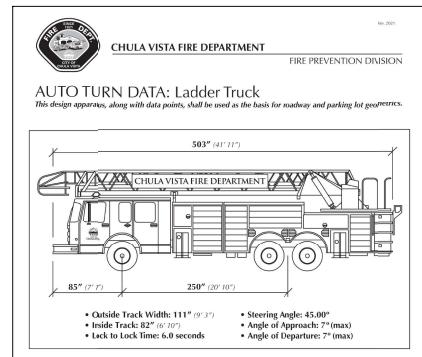


CREATIVE OPPORTUNITIES QOZB, LP

OTAY RIVER BUSINESS PARK
PARCEL 2 (LOT 12 OF CHULA VISTA TRACT NO. PCS 16-0007)
FAIRFIELD STREET CHULA VISTA, CA


SITE PLAN
12/07/2021
1:300
1380 Evening Creek Drive South | Suite 25
San Diego, CA 92128
858.793.0777 | scad.com

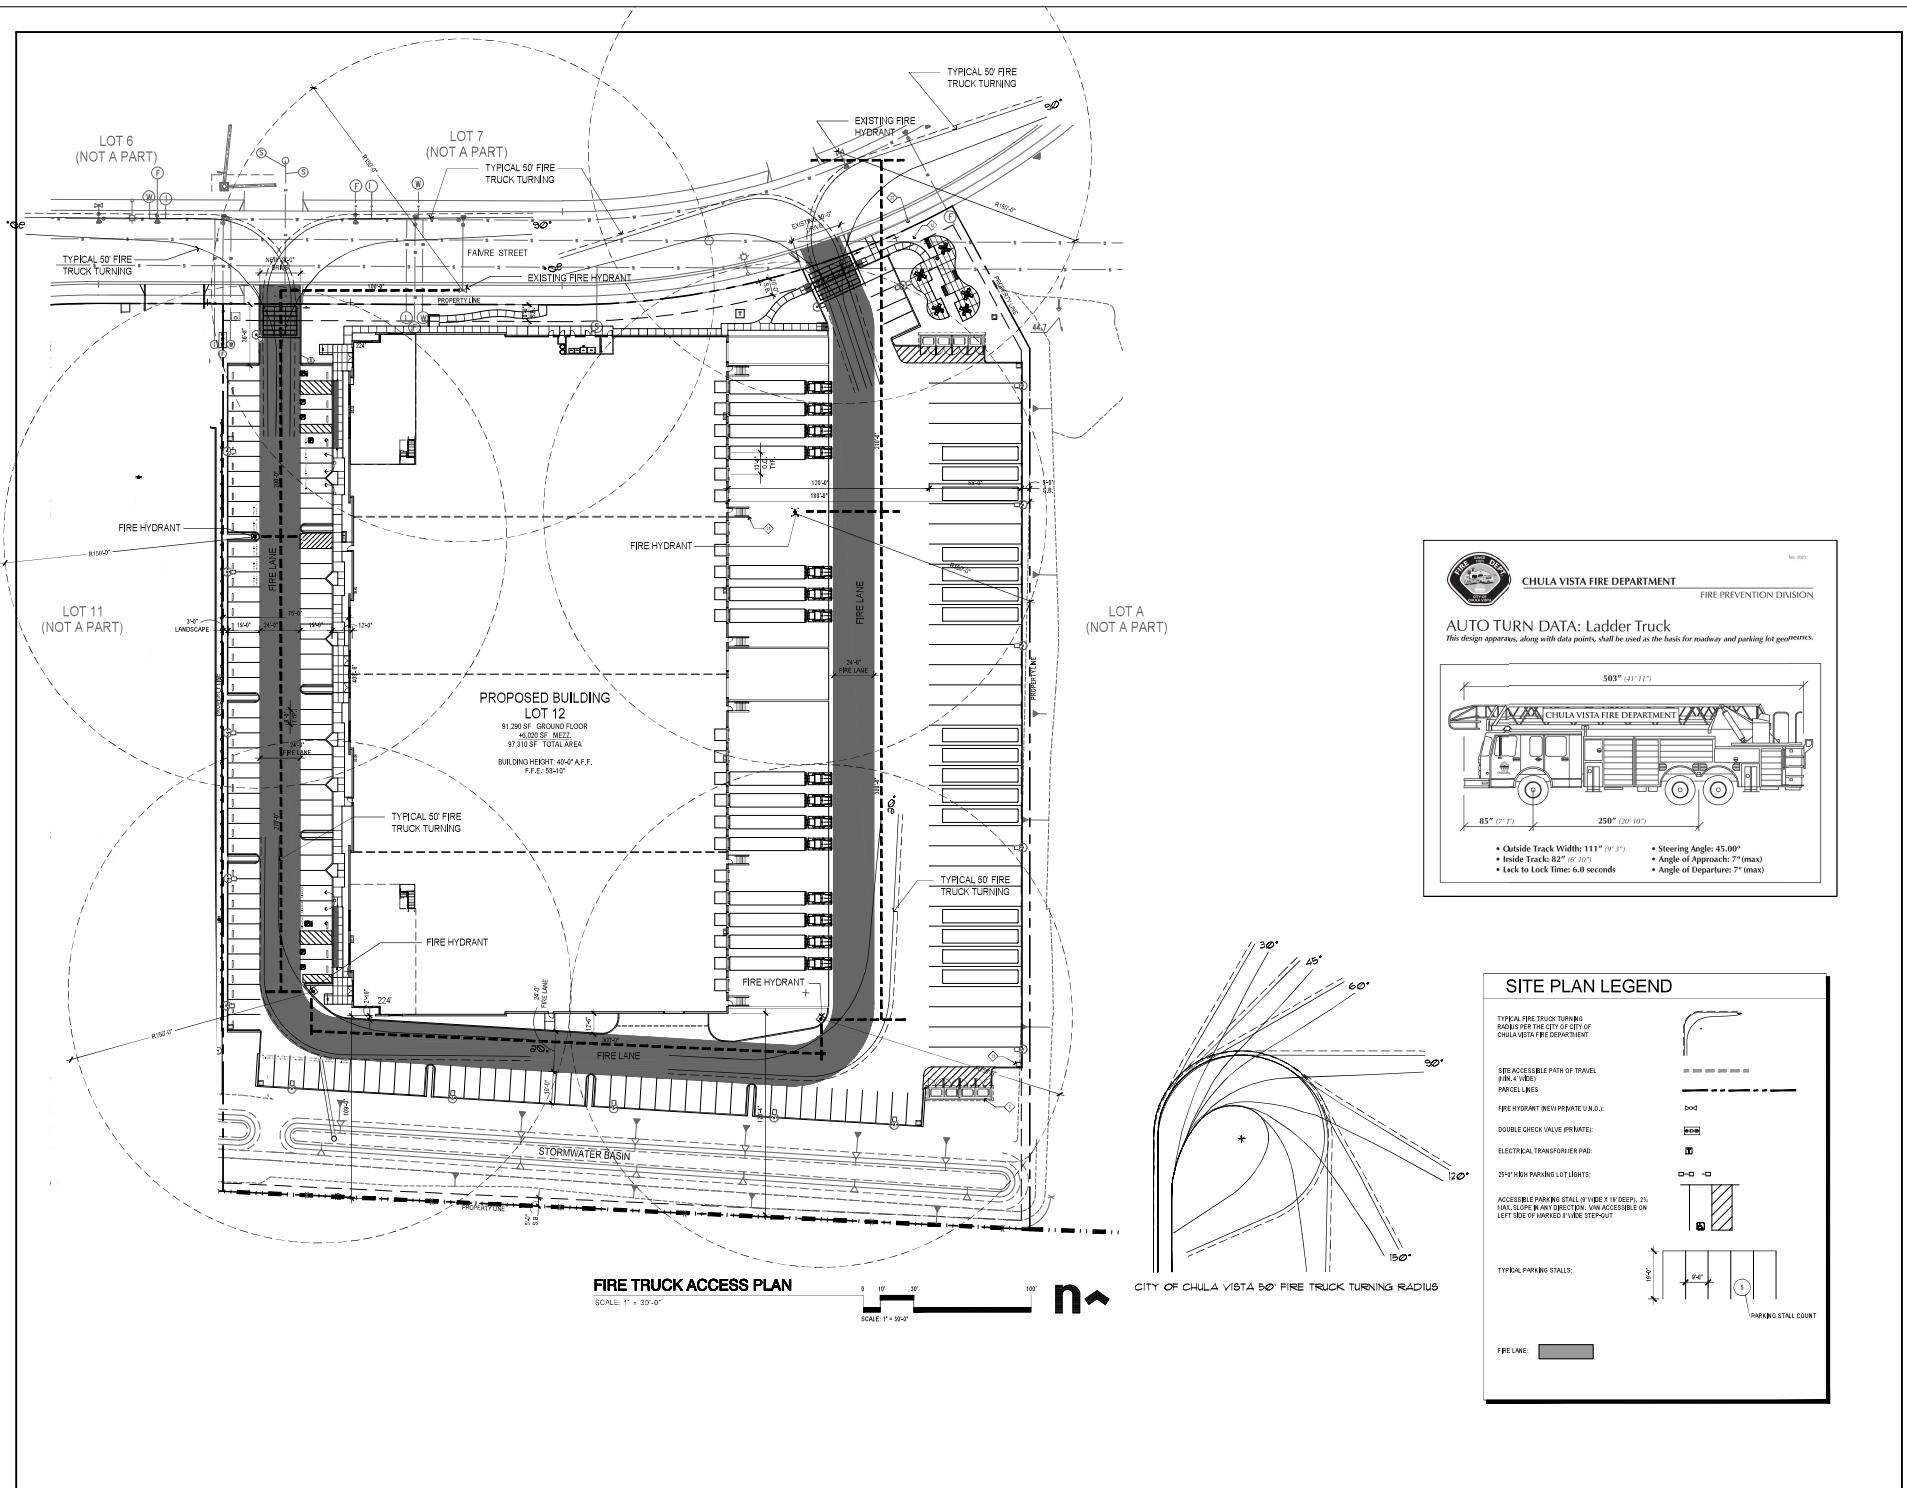

<p>PEDESTRIAN RAMP DIAGRAM CBC 2019 2019 ADASD 14' = 12'</p>	<p>ACCESSIBLE RAMP @ CONC. WALK CBC 2019 2019 ADASD 14' = 12'</p>	<p>ACCESSIBLE PARKING STALL TYP. 16' = 12'</p>
<p>RAMP LEADING TO DOOR WAY CBC SECTION 11B-052.5 AND 11B-052.1</p>	<p>NO PARKING & PED. WALKWAY STRIPING CBC 2019 2019 ADASD 14' = 12'</p>	<p>ACCESSIBLE PARKING SIGN 17' = 12'</p>
<p>RAMP WITH TURNING PLATFORM PER CBC 11B-050 AND 11B-052</p>	<p>ACCESSIBLE PARKING SIGN-VAN 18' = 12'</p>	<p>TRASH ENCLOSURE PLAN 19' = 12'</p>
<p>DETECTABLE WARNING @ ZERO CURB 20' = 12'</p>	<p>CONCRETE WHEEL STOP 11' = 12'</p>	<p>TRASH ENCLOSURE ELEVATION 21' = 12'</p>
<p>DETECTABLE WARNING @ VAN CURB 22' = 12'</p>	<p>TRASH ENCLOSURE ELEVATIONS- SIDE 23' = 12'</p>	<p>SECTION • TRASH ENCLOSURE 24' = 12'</p>
<p>CONCRETE ACCESSIBILITY SYMBOL 25' = 12'</p>	<p>TRASH GATE JAMB AT CENTER POST 26' = 12'</p>	<p>TRASH GATE JAMB 27' = 12'</p>

SCA
STRUCTURE
ARCHITECTURE

13280 Evening Creek Drive South | Suite 125
San Diego, CA 92128 | 1-800-123-1234

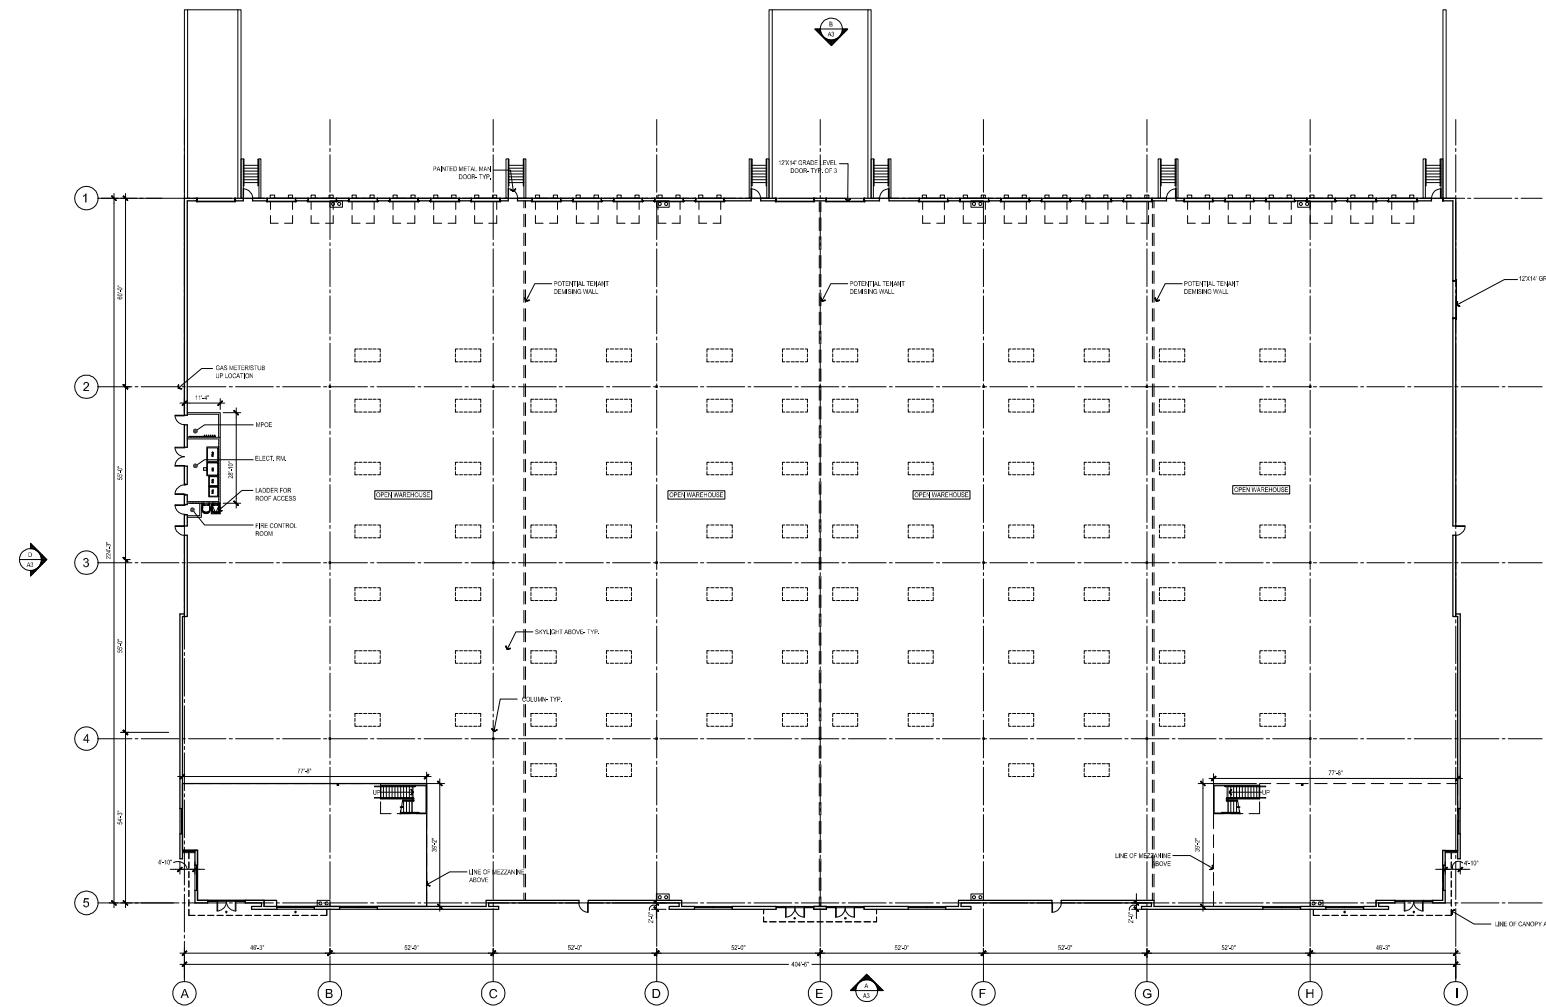

DR PROJECT # DR2140906

Revision Dates

A1			

Issue Dates

1st Design Review	12/01/2021
2nd Design Review	04/26/2022
3rd Design Review	06/06/2022
Bld Set	-
Permit Set	-
Construction Set	-

Drawing Date

12/07/2021

Check By

NDB

Drawn By

NDB

Scale


AS NOTED

Job Number

11009.S1201


Sheet Number

4 OF 17

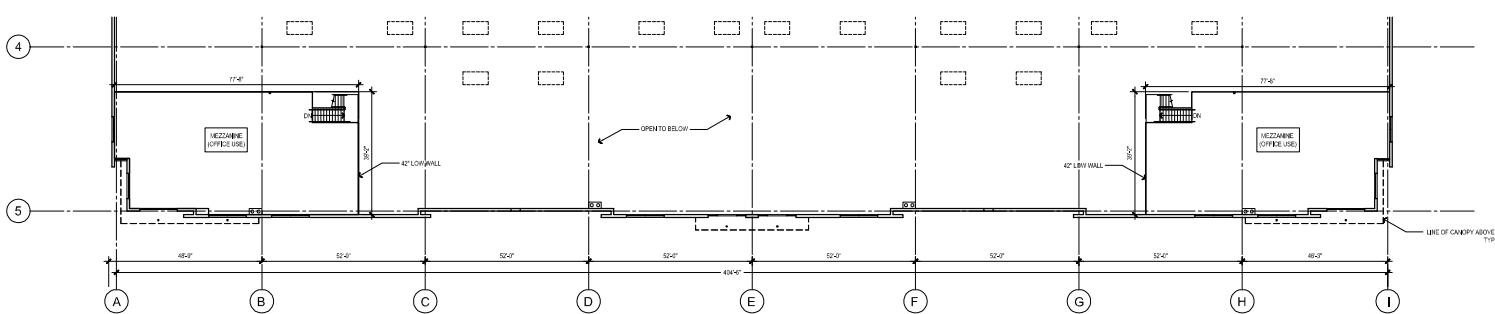

CREATIVE OPPORTUNITIES QOZB, LP
OTAY RIVER BUSINESS PARK
PARCEL 2 (LOT 12 OF CHULAVISTA TRACT NO. PCS 18-007)

ROOF PLAN

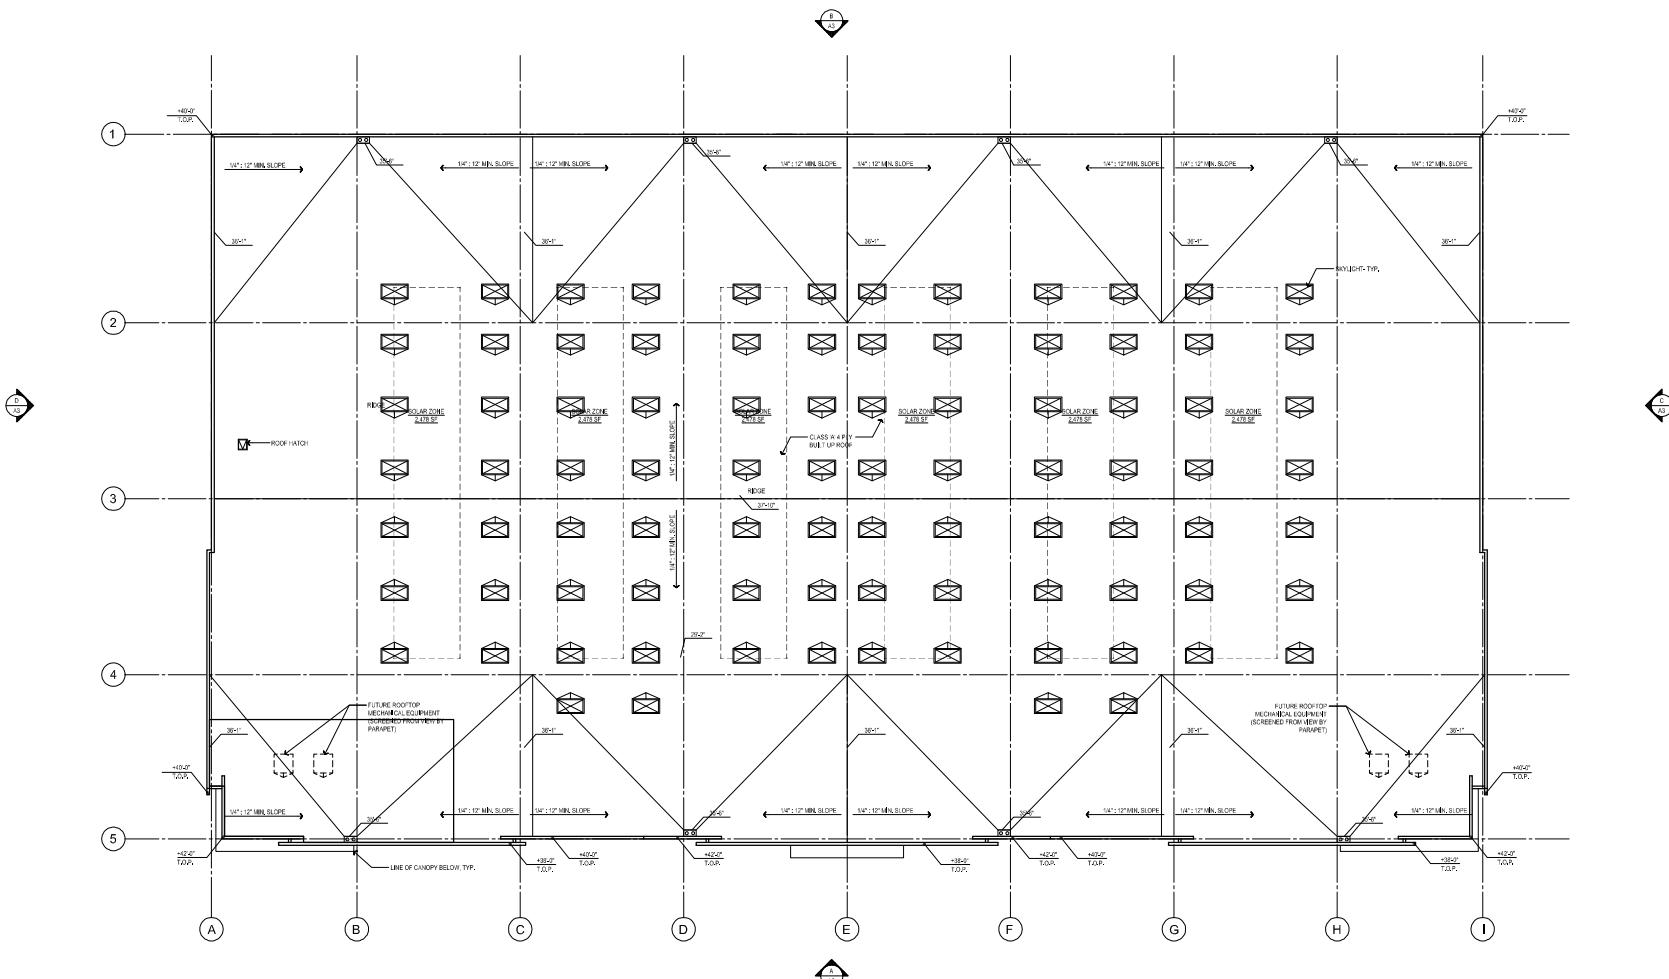

LOT 12-ROOF PLAN

SCALE: 1/16" = 1'-0"



ROOF CALCULATIONS:

SKYLIGHT PER CEC SECTION 10.3 (MINIMUM % OF ROOF AREA)
ROOF AREA = 1290 SF
REQUIRED SKYLIGHT AREA = 91.200 x 3% = 2.730 SF
MINIMUM SKYLIGHT SIZE = 4' x 6' (24 SF)
TOTAL NUMBER OF SKYLIGHTS REQUIRED FOR DAYLIGHTING = 91 / 2.730

SOLAR ZONE CALCULATION

- RI-260 SF TOTAL ROOF AREA
- 2,730 SF TOTAL REQUIRED SKYLIGHT AREA
- 38'-0" x 13'-0" = 493 SF
- 14.01 SF REQUIRED SOLAR AREA
- 14,861 SF PROPOSED SOLAR AREA

ROOF PLAN LEGEND:

- ROOF ELEVATION FROM FLOOR TO TOP OF ROOF SHEATHING
- TOP OF PARAPET ELEVATION FINISH FLOOR TO TOP OF PARAPET (TYP UZA)
- DENOTES MIN. ROOF SLOPE FLOW LINE
- SINGLE CURB MOUNTED SING. DOME SKYLIGHT WITH SMOKE HATCH AND FALL PROTECTION PER CEC REQUIREMENTS


A1		

1st Design Review	12/01/2021
2nd Design Review	04/26/2022
3rd Design Review	06/06/2022
Bld Set	-
Permit Set	-
Construction Set	-
Drawing Date	12/07/2021
Check By	NDB
Drawn By	NDB
Scale	AS NOTED
Job Number	11009.S1201
Sheet Number	5 OF 17


CREATIVE OPPORTUNITIES QOZB, LP

OTAY RIVER BUSINESS PARK
PARCEL 2 (LOT 12 OF CHULAVISTA TRACT NO. PCS 18-0007
FAIRVIEW STREET CHULA VISTA, CA


EXTERIOR ELEVATIONS

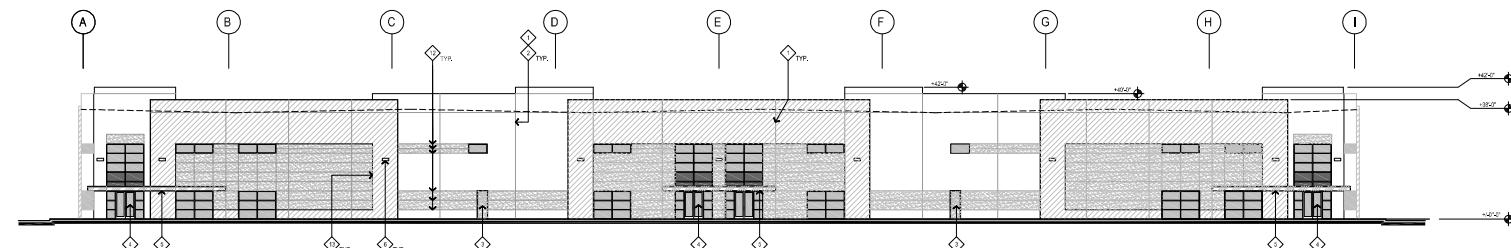


(A) WEST ELEVATION
SCALE: 1/16" = 1'-0"

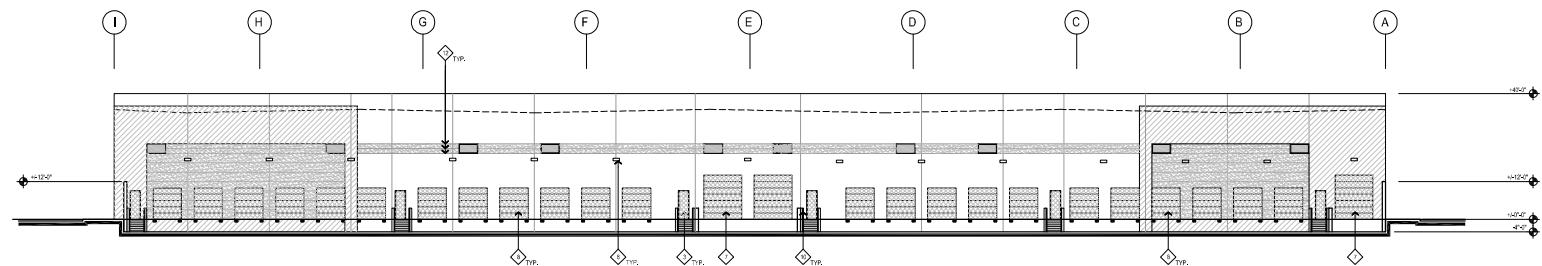

(B) EAST ELEVATION
SCALE: 1/16" = 1'-0"

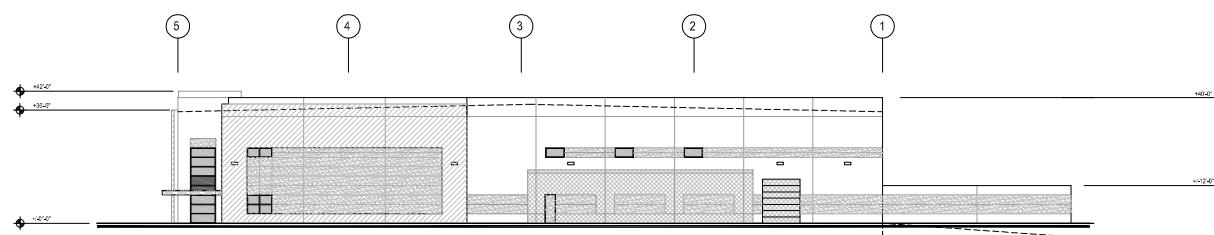

(C) SOUTH ELEVATION
SCALE: 1/16" = 1'-0"

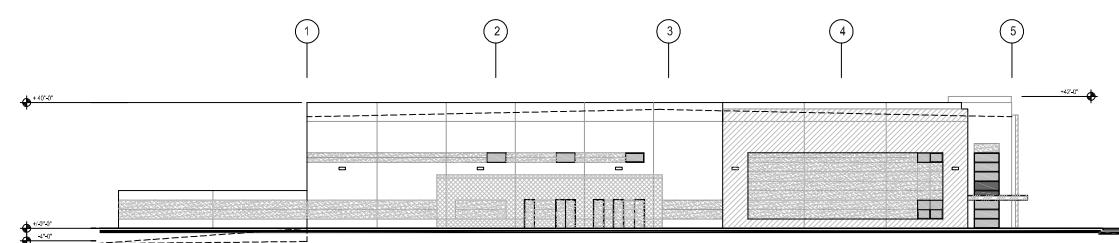

(D) NORTH ELEVATION
SCALE: 1/16" = 1'-0"

MATERIAL SCHEDULE:

24X48 ALUMINUM STOREFRONT FRONT SET SYSTEM w/CAPTURED HORIZONTALS AND VERTICALS - 5/8" DUAL TINTED GLAZING
24X48 ALUMINUM STOREFRONT FRONT SET SYSTEM w/CAPTURED HORIZONTALS AND VERTICALS - 5/8" SOLARBLIN 60 (2) SOLARBLIN + CLEAR, 100% VLT
24X48 ALUMINUM STOREFRONT FRONT SET SYSTEM w/CAPTURED HORIZONTALS AND VERTICALS - 5/8" SOLARBLIN 60 (1) SOLARBLIN W/ 40% VLT IN SWING ORIG COAT 300, SOLARBLIN SOLARBLIN
PARTED CONCRETE TILT-UP PANEL FIELD COLOR: SV 600 SMOKE FALL
PARTED CONCRETE TILT-UP PANEL ACCENT COLOR: SV 910 DELTA GRAY
PARTED CONCRETE TILT-UP PANEL ACCENT COLOR: SV 910 TBL 120
PARTED CONCRETE TILT-UP PANEL ACCENT COLOR: SV 908 GRIZZLY GRAY
PRE-FINISHED METAL PANEL ALPOLIC CYC GREY

ELEVATION KEY NOTES:

NOT ALL KEY NOTES ARE USED ON THIS SHEET


- ◆ CONCRETE TILT-UP PANEL JOINT
- ◆ 3/4" V GROOVE REVEAL IN CONCRETE TILT-UP PANEL
- ◆ PAINTED METAL MANDORL
- ◆ MEDIUM STEEL STOREFRONT DOOR INDIVIDUAL PANEL GLAZING
- ◆ METAL STUD FRAMED CANOPY w/PLYWOOD SHEATHING, WATERPROOFING MEMBRANE, AND 10' PREFORMED ALUMINUM PANEL SYSTEM
- ◆ WALL MOUNTED LIGHT FIXTURE
- ◆ 12X14 PAINTED GRADE LEVEL DOOR
- ◆ 8X17 PAINTED DOCK LEVEL DOOR
- ◆ ROOT OVERFLOW THRESHOLD SLIPPER
- ◆ METAL HANDRAIL - PAINTED SV 600 SMOKE FALL
- ◆ TRASH ENCLOSURE
- ◆ 2" HORIZONTAL REVEAL IN TILT-UP PANEL
- ◆ 1" HORIZONTAL REVEAL IN TILT-UP PANEL
- ◆ METAL STUD FRAMED CANOPY w/PLYWOOD SHEATHING, WATERPROOFING MEMBRANE, AND 10' PREFORMED ALUMINUM PANEL SYSTEM - ALPOLIC CYC GREY
- ◆ CONCRETE STAIRS - NATURAL GREY

DR PROJECT #	DR140906
Revision Dates	
A1	
A2	
A3	
Issue Dates	
1st Design Review	12/01/2021
2nd Design Review	04/25/2022
3rd Design Review	06/06/2022
Bid Set	-
Permit Set	-
Construction Set	-
Drawing Date	12/07/2021
Check By	NDB
Drawn By	NDB
Scale	AS NOTED
Job Number	11009.S1201
Sheet Number	6 OF 17



Planning	.
Design Review	.
Plan Check	.
Bld Set	.
Permit Set	.
Construction Set	.


Check By	.
Drawn By	.
Scale	SEE PLAN
Job Number	11009 S1701
Sheet Number	OF

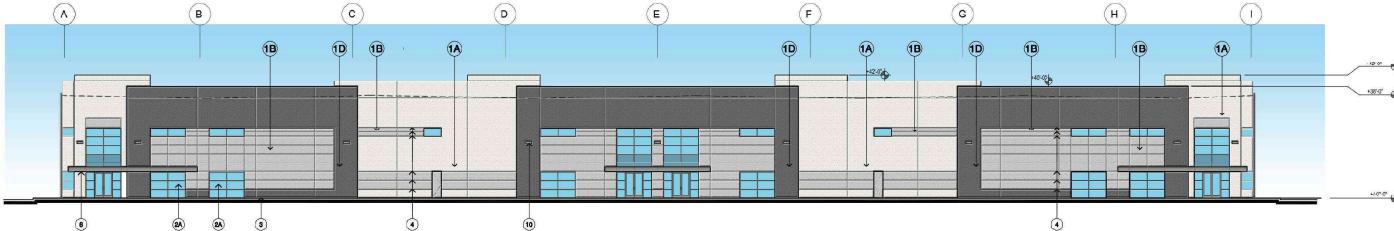

West Exterior Elevation

SCALE: 1" = 20'-0"


20' 0" 20' 0" 20' 0" 20'

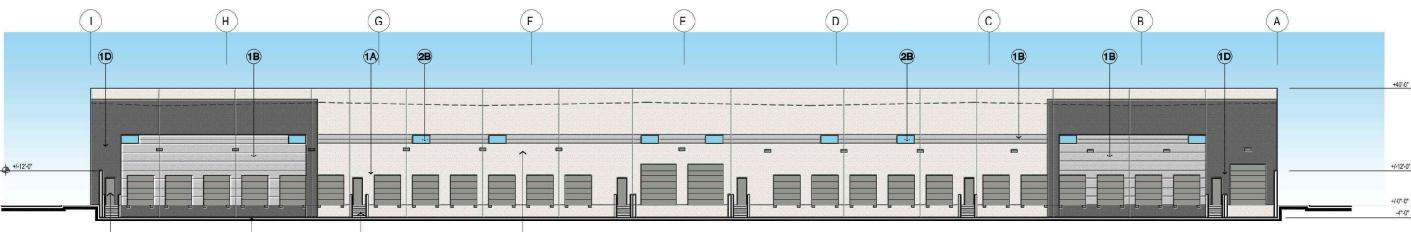

East Exterior Elevation

SCALE: 1" = 20'-0"


20' 0" 20' 0" 20' 0" 20'

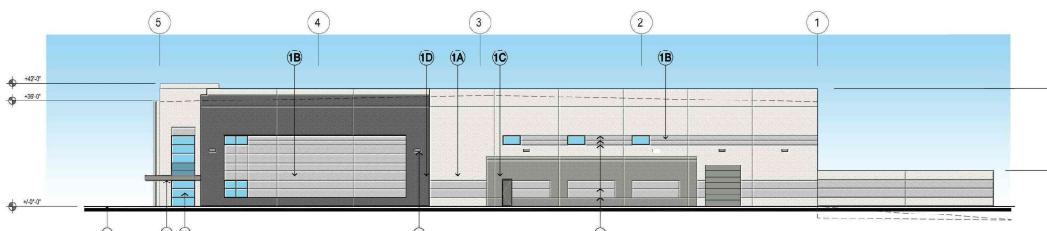

South Exterior Elevation

SCALE: 1" = 20'-0"

20' 0" 20' 0" 20' 0" 20'

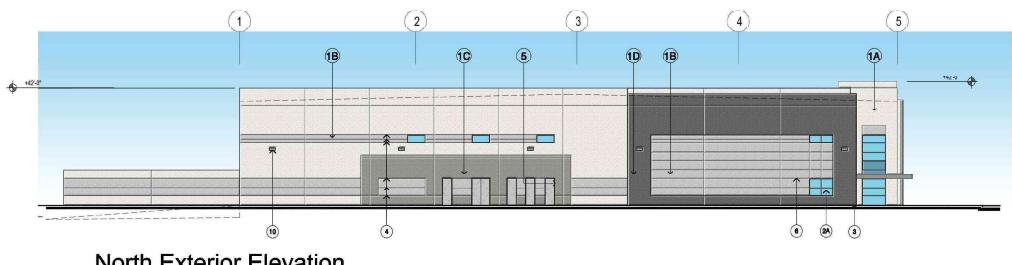

North Exterior Elevation

SCALE: 1" = 20'-0"

20' 0" 20' 0" 20' 0" 20'



LEGEND

- (1A) PAINTED CONCRETE WALL
COLOR: SW 6000 SNOWFALL
- (1B) PAINTED CONCRETE WALL
COLOR: SW 2860 CHELSEA GRAY
- (1C) PAINTED CONCRETE WALL
COLOR: SW 2860 CHELSEA GRAY
- (1D) PAINTED CONCRETE WALL
COLOR: SW 7068 GRIZZLE GRAY
- (2A) 2MA 1/2" ALUMINUM STOREFRONT, FRONT SET SYSTEM,
w/CAPTIVATED HORIZONTAL ANGLE & VERTICAL w/ DIHAL PAN
THE GLAZING IS SOLARSHADE 60 (2) SOLARSHADE + CLEAR
MULLIONS: CLEAR ANODIZED
- (2B) ALUMINUM STOREFRONT SYSTEM @ WAREHOUSE REAR
FAACIS ONLY - 2TH 1/2" ALUMINUM FRONT, FRONT SET SYSTEM
THE GLAZING IS SOLARSHADE 60 (2) SOLARSHADE
MULLIONS: CLEAR ANODIZED
- (3) FINISHED GRADE
- (4) 2" HORIZONTAL REVEAL IN TILT UP PANEL
- (5) VERTICAL REVEAL IN TILT UP PANEL
- (6) METAL STUD FRAMED CANOPY w/ 1/2" WOOD SHEATHING,
WATERPROOFING MEMBRANE, AND 18" PREFORMED
ALUMINUM PANEL SYSTEM - ALUJULI UVG URE
- (7) PTD. MTL. MAN DOOR COLOR TBD
- (8) CONCRETE FIRE DEPARTMENT ACCESS STAIR
- (9) COILING DOOR
- (10) WALL MOUNTED LIGHT, COLOR AND FINISH TO MATCH WINDOW
MULLION COLOR

LEGEND SHEETS 2 AND 3

PROPOSED IMPROVEMENTS

IMPROVEMENT	STANDARD OWS.	SIMBL
STORM DRAIN PIPE-SIZE/TYPE PER PLAN (PVT)		
TYPE "A" CLEAN OUT (PVT)	0-09	
SPILL CONTAINMENT VAULT (PVT)		
W/MANUAL SHUT-OFF VALVE		
CONCRETE LOG (PVT)	D-63	
INLET BOX-SIZE PER PLAN (PVT) BROOKS PRODUCT (OR EQUAL)		
TYPE "B" CURB AND GUTTER (PVT)	0-02	
6" CURB (PVT)	0-01	
GRADE BREAK		
TOP/ANGLE OF SLOPE		
SMALE WITH DIRECTION OF FLOW		
FINISHED SURFACE ELEVATION		
FLOW LINE ELEVATION		
TOP OF GRADE ELEVATION		
DAYLIGHT LINE /LIMIT OF REMEDIAL GRADING (APPROX.)		
A.C. PAVING PER SOILS ENGINEER RECOMMENDATION		
CONCRETE WALKWAY	0-07	
TRUNCATED DOMES		
SIGN		
RIGHT TURN ONLY	MUTCD 2014ED REV 2 R3-5(RT)	
FIRE HYDRANT ASSEMBLY	SASD SD-6 & 7	
PROPOSED REDUCED PRESSURE DETECTOR ASSEMBLY	SASD 15-4	
PROPOSED POST INDICATING VALVE/FIRE DEPARTMENT CONNECTION		
PROPOSED DOMESTIC REDUCED PRESSURE ASSEMBLY	SASD 15-8	
CONSTRUCT PRIVATE STRAIGHT HEADWALL TYPE A	SASD D-30	
INSTALL PRIVATE RIP-RAP NO. 2 BACKING	SASD D-40	

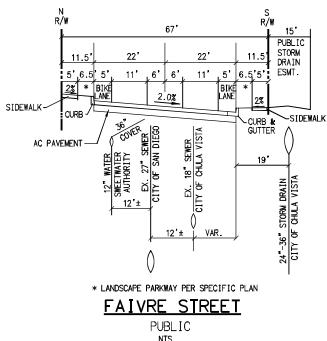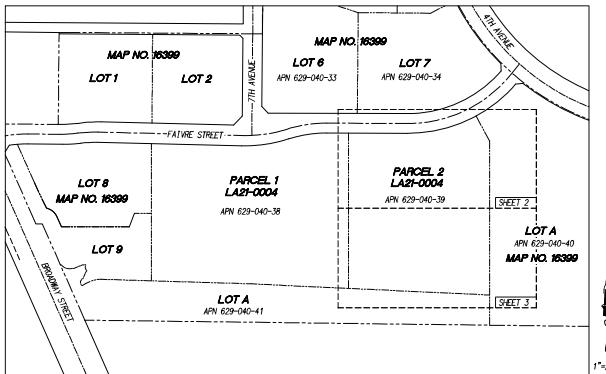


TITLE SHEET	SHEET #/RANGE
GRADING & DRAINAGE	1
EROSION CONTROL PLAN	2 & 3
	4

EXISTING IMPROVEMENTS

IMPROVEMENT	STANDARD OWS.	SIMBL
DESIGN BASIN RISER		
2" WATER SERVICE		
2" IRRIGATION SERVICE		
FIRE LATERAL	12" PVC C900	
6" SEWER LATERAL W/BACKFLOW PREVENTER S.D.R.S.D. NOS. SS-01		
EX. SEWER END CAP		
FIRE HYDRANT ASSEMBLY	S.A.S.D. SD-6 & 7	

EARTHWORK QUANTITIES

CUT: 7,974 C.Y.
FILL: 10,483 C.Y.
IMPACT: 2,250 C.Y.
AND 10% GRADED: 5.88 ACRES
GRAVING QUANTITIES ARE ESTIMATED FOR BONDING PURPOSES ONLY AND ARE NOT
TO BE USED FOR FINAL PAYMENT QUANTITIES. CONTRACTOR TO PERFORM THEIR OWN
CALCULATIONS.
QUANTITIES DO NOT INCLUDE SPOILS FROM BUILDING FOOTINGS, RETAINING WALLS AND
UTILITY TRENCHES.

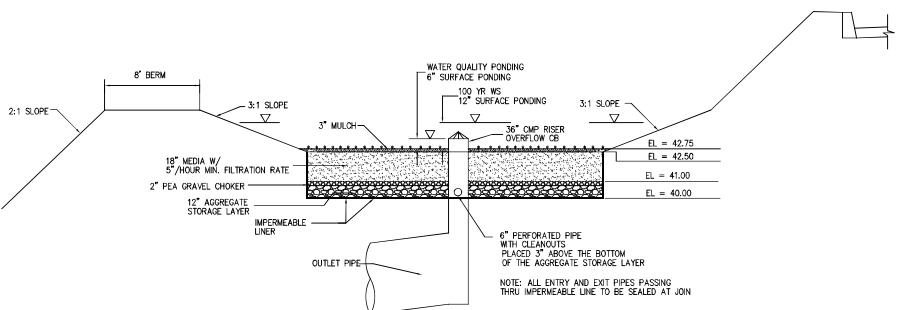

CITY OF CHULA VISTA		DEVELOPMENT SERVICES DEPARTMENT	Drawing No.
GRADING AND DRAINAGE PLANS FOR: OTAY RIVER BUSINESS PARK			SHEET 1 OF 4


PARCEL 2 (LOT 12 OF CHULA VISTA TRACT NO. PCS 16-0007)

W.O. NO.

JN 21-039

CONSTRUCTION RECORD	REFERENCES	By	REVISIONS	Date App'd	BENCH MARK	SCALE	Designed by	Brown by	Checked By
Contractor _____	_____	_____	_____	_____	HORIZONTAL Elev. of BRIDGE ON BRIDGE CURB ELEV. = 40.310' (NAVD88)	Plots Prepared Under Supervision Of	S.M.D.	G.W.D.	K.S.S.
Inspector _____	_____	_____	_____	_____	VERTICAL N/A	Date			
Date Completed _____	_____	_____	_____	_____	IMPERMEABLE LINER KAWAI S. SHETS	R.C.E. No.	48592		

DR21-0036

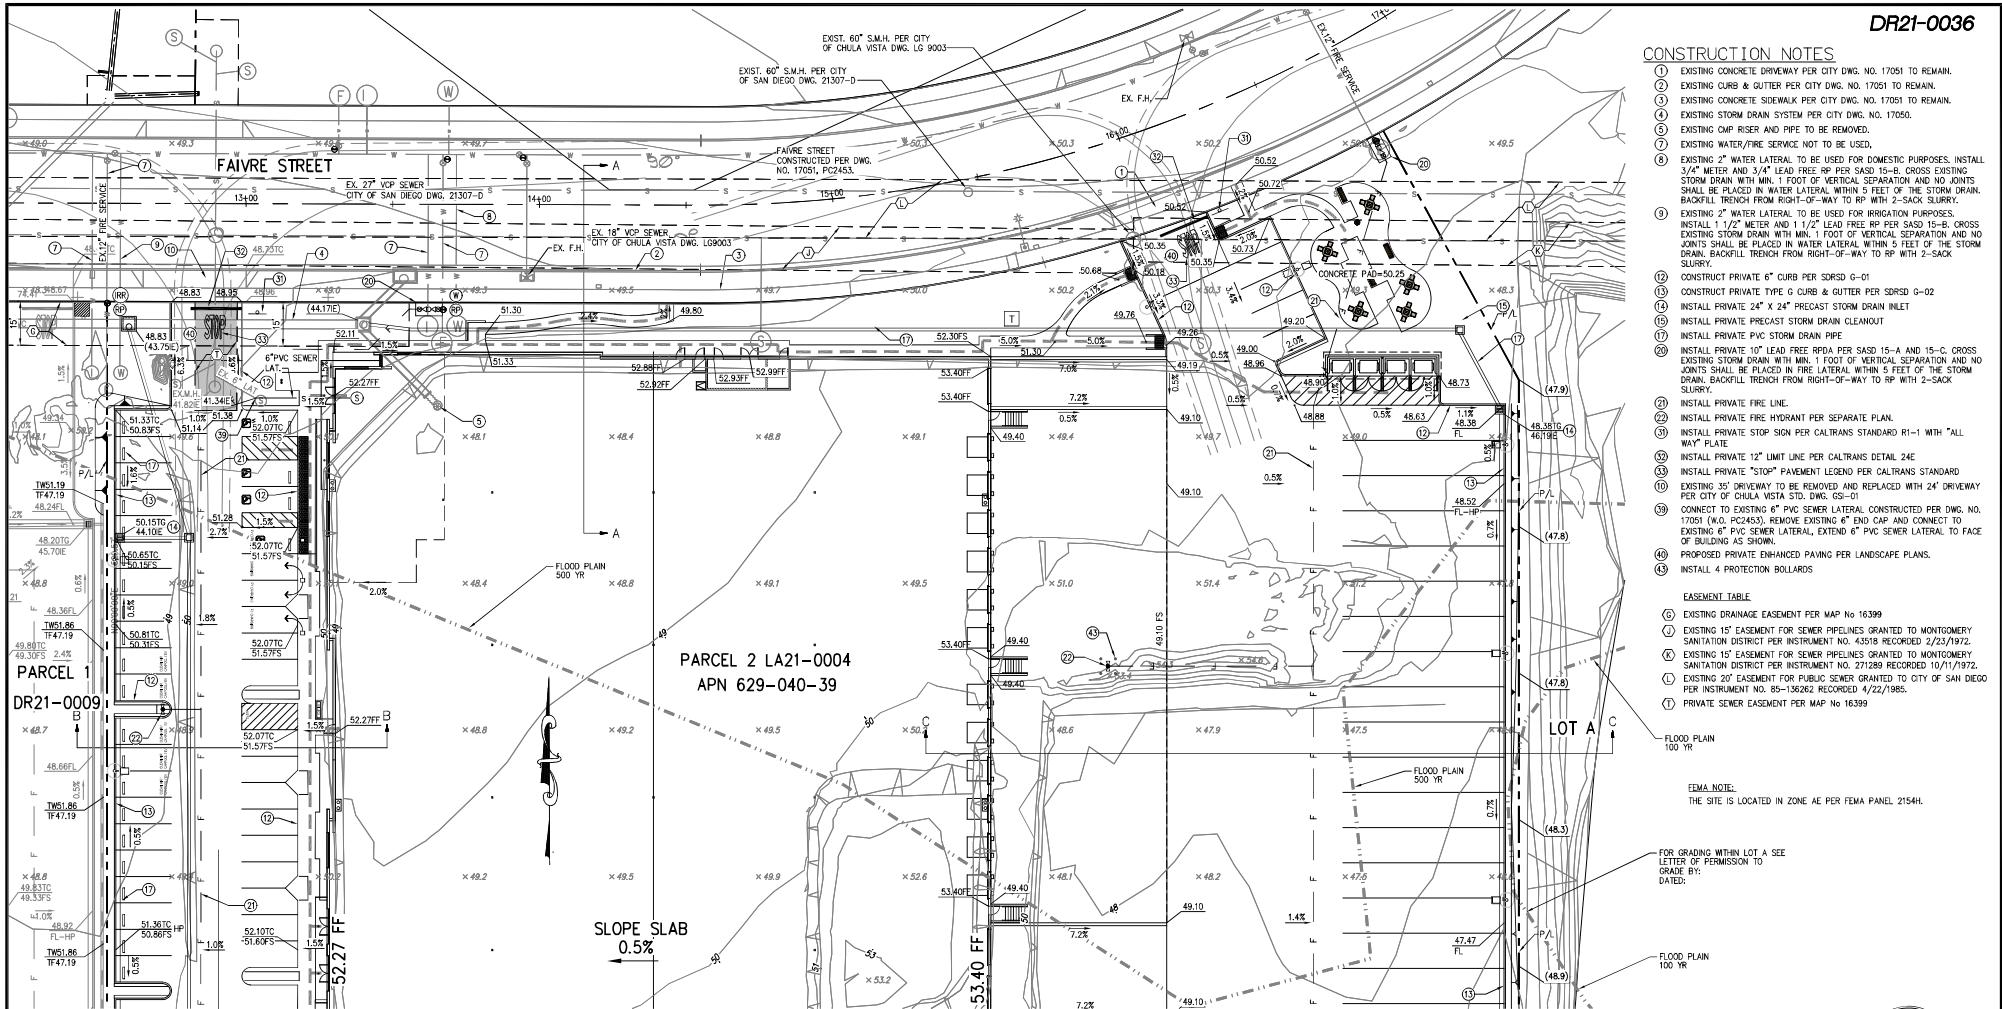


CONSTRUCTION RECORD	REFERENCES	By	REVISIONS	Date	App'd	BENCH MARK	SCALE	Designed by	Brown by	Checked By
Contractor _____	_____	_____	_____	_____	_____	CITY OF CHULA VISTA BLDG. BMR # 1600 E SIDE BROADWAY 20' S OF FAIVRE ST. • THE END OF BRIDGE ON BRIDGE CURE ELEV. +46.310' (NAVD88)	HORIZONTAL Plots Prepared Under Supervision Of S.M.D.	G.W.D.	K.N.S.	
Inspector _____	_____	_____	_____	_____	_____	•	VERTICAL N/A	Plots Prepared Under Supervision Of S.M.D.	Date	
Date Completed _____	_____	_____	_____	_____	_____	•	KAWAI, S. SHEETS	R.C.E. No.	48592	

CITY OF CHULA VISTA		DEVELOPMENT SERVICES DEPARTMENT	Drawing No.
GRADING AND DRAINAGE PLANS FOR: OTAY RIVER BUSINESS PARK	PARCEL 2 (LOT 12 OF CHULA VISTA TRACT NO. PCS 16-0007)		SHEET 2 OF 4



FOR CONTINUATION SEE SHEET 2

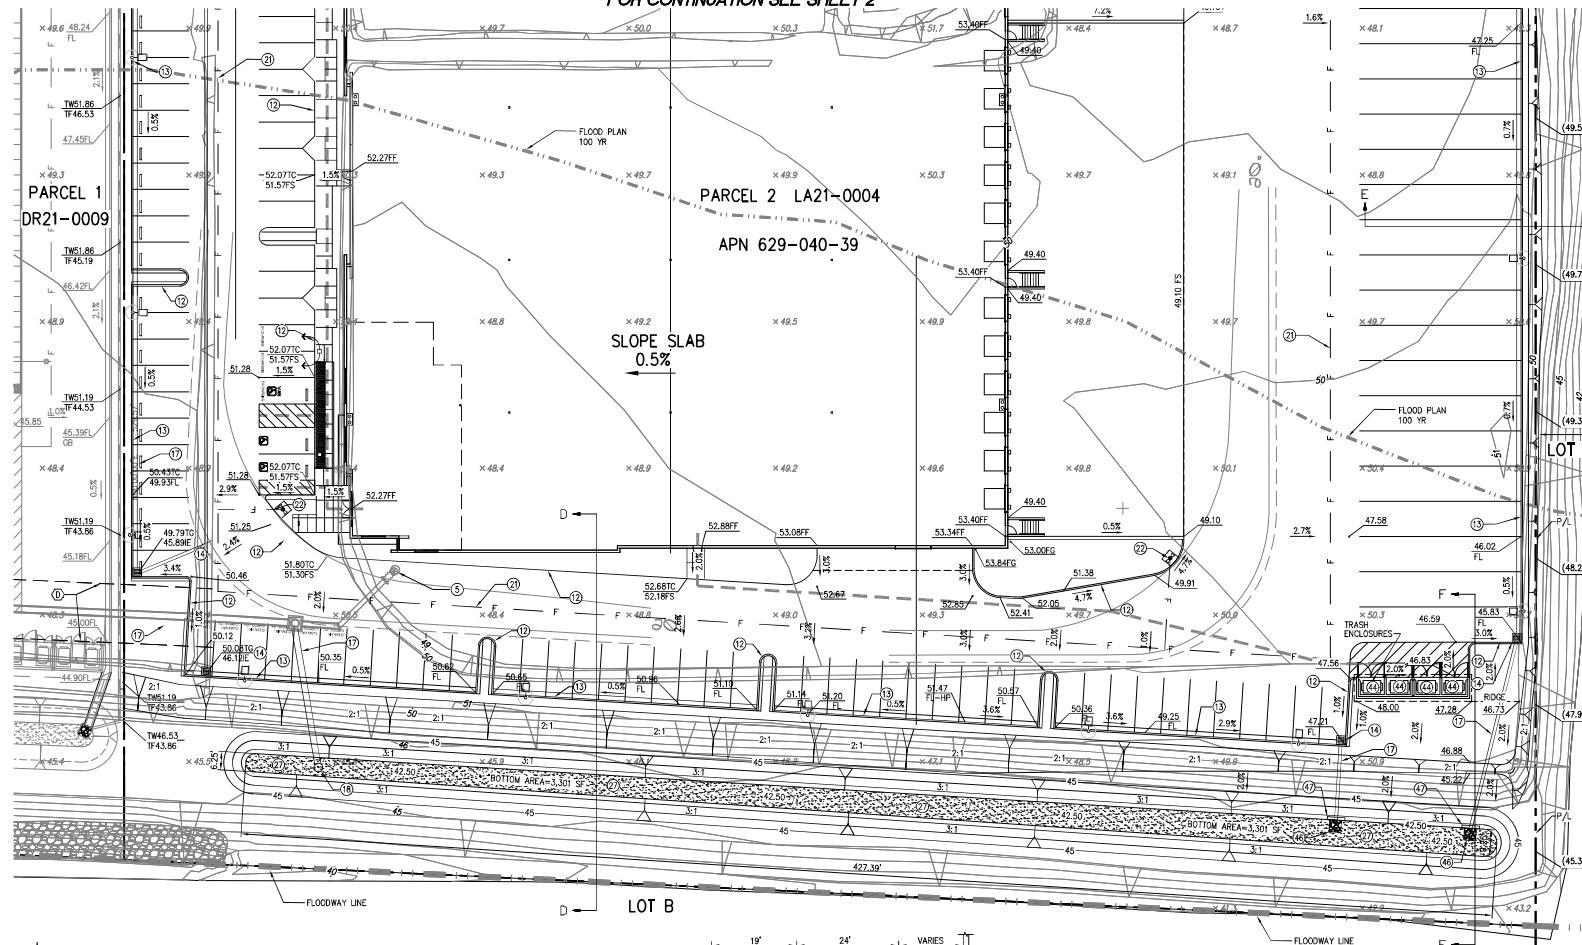

CONSTRUCTION NOTES


- (5) EXISTING CMP RISER AND PIPE TO BE REMOVED.
- (12) CONSTRUCT PRIVATE 6" CURB PER SDRSD G-01
- (13) CONSTRUCT PRIVATE TYPE C CURB & GUTTER PER SDRSD G-02
- (14) INSTALL PRIVATE 24" X 24" PRECAST STORM DRAIN INLET
- (15) INSTALL PRIVATE PVC STORM DRAIN PIPE
- (16) INSTALL PRIVATE 36" CMP RISER WITH TRASH RACK PER DETAIL ON SHEET 6.
- (21) INSTALL PRIVATE FIRE LINE.
- (22) INSTALL PRIVATE FIRE HYDRANT PER SEPARATE PLAN.
- (27) CONSTRUCT PRIVATE BIOFILTRATION BASIN (BMP # 2) PER DETAIL ON SHEET 6.
- (44) PROPOSED TRASH ENCLOSURE PER ARCHITECT PLANS
- (45) INSTALL PRIVATE NO. 2 BACKING RIP-RAP PER SDRSD D-40.
- (47) CONSTRUCT PRIVATE STRAIGHT HEADWALL TYPE A PER SDRSD D-30.

FOR GRADING WITHIN LOT A SEE
LETTER OF PERMISSION TO SEE
GRADE BY:
DATED:

FEMA NOTE:
THE SITE IS LOCATED IN ZONE AE AS PER FEMA PANEL 215AH.

EASEMENT TABLE

- (D) PRIVATE STORM DRAIN EASEMENT TO BE GRANTED AT THE TIME OF SALE OF LOT PER MAP NO 16399

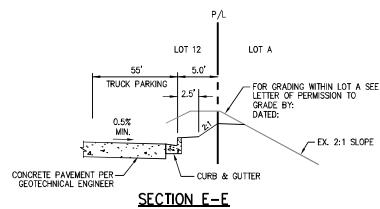

CONSTRUCTION RECORD	REFERENCES	By	REVISIONS	Date App'd
Contractor _____	_____	_____	_____	_____
Inspector _____	_____	_____	_____	_____
Date Completed _____	_____	_____	_____	_____



SCALE	Designed by	Drawn by	Checked by
HORIZONTAL S.M.D.	G.W.D.	G.W.D.	K.S.S.
Vertical N/A	PLOTS PREPARED UNDER SUPERVISION OF	DATE	
	KANAL S. SHETS	R.C.E. No.	48592

CITY OF CHULA VISTA	DEVELOPMENT SERVICES DEPARTMENT	Drawing No.
GRADING AND DRAINAGE PLANS FOR: OTAY RIVER BUSINESS PARK PARCEL 2 (LOT 12 OF CHULA VISTA TRACT NO. PCS 16-0007)		SHEET 3 OF 4

EROSION CONTROL	
STABILIZED CONSTRUCTION ENTRANCE	CASQA STD. DWG.
GRAVEL BAGS	TC-1, TC-3
PERIMETER CONTROL T.B.D. BY CONTRACTOR	SE-8, SE-10
SILT FENCE/GRAVEL BAGS BARRIER/FIBER ROLLS	SE-1, SE-8
COMPOST SOCKS	SE-5, SE-13
MATERIAL DELIVERY AND STORAGE AREA	VM-1
MATERIAL USE	WM-2
STOCKPILE MANAGEMENT	WM-3
SPILL PREVENTION AND CONTROL	WM-4
SOLID WASTE MANAGEMENT AREA	WM-5
HAZARDOUS WASTE MANAGEMENT AREA	WM-6
CONCRETE WASTE MANAGEMENT AREA	WM-8
SANITARY/SEPTIC WASTE MANAGEMENT AREA	WM-9
STREET SWEEPING AND VACUUMING	SC-7



VM-1
WM-2
WM-3
WM-4
WM-5
WM-6
WM-8
WM-9
SC-7

NOTE TO THE CONTRACTOR

-CONSTRUCTION SITE CONDITIONS MAY DICTATE THE LOCATION OF THE BMPs. A CERTIFIED PROFESSIONAL IN EROSION & SEDIMENT CONTROL OR SWPPP PRACTITIONER MAY DETERMINE CHANGES ACCORDINGLY. BMP DATA SHEET GUIDELINES WILL BE FOLLOWED REGARDLESS OF LOCATION.


TEMPORARY EROSION CONTROL AND /OR FINAL STABILIZATION BMPs FOR DISTURBED SOIL AREAS	
ONE OF THE FOLLOWING BMPs SHOULD BE APPLIED TO EXPOSED SOIL AREAS ON THE SITE WHILE INACTIVE.	
EC-3 HYDRAULIC MULCH	
EC-5 SOIL BINDERS	
EC-6 WOOD CHIPS	
EC-7 TEXTILES AND MATS (BIODEGRADABLE)	
EC-8 WOOD MULCHING	



K & S K & S ENGINEERING, INC.
Planning . Engineering . Surveying
7801 Mission Center Court, Suite 100 San Diego, CA 92108
(619) 296-5565 Fax: (619) 296-5564

0 15 30 60 90

GRAPHIC SCALE: 1" = 30'

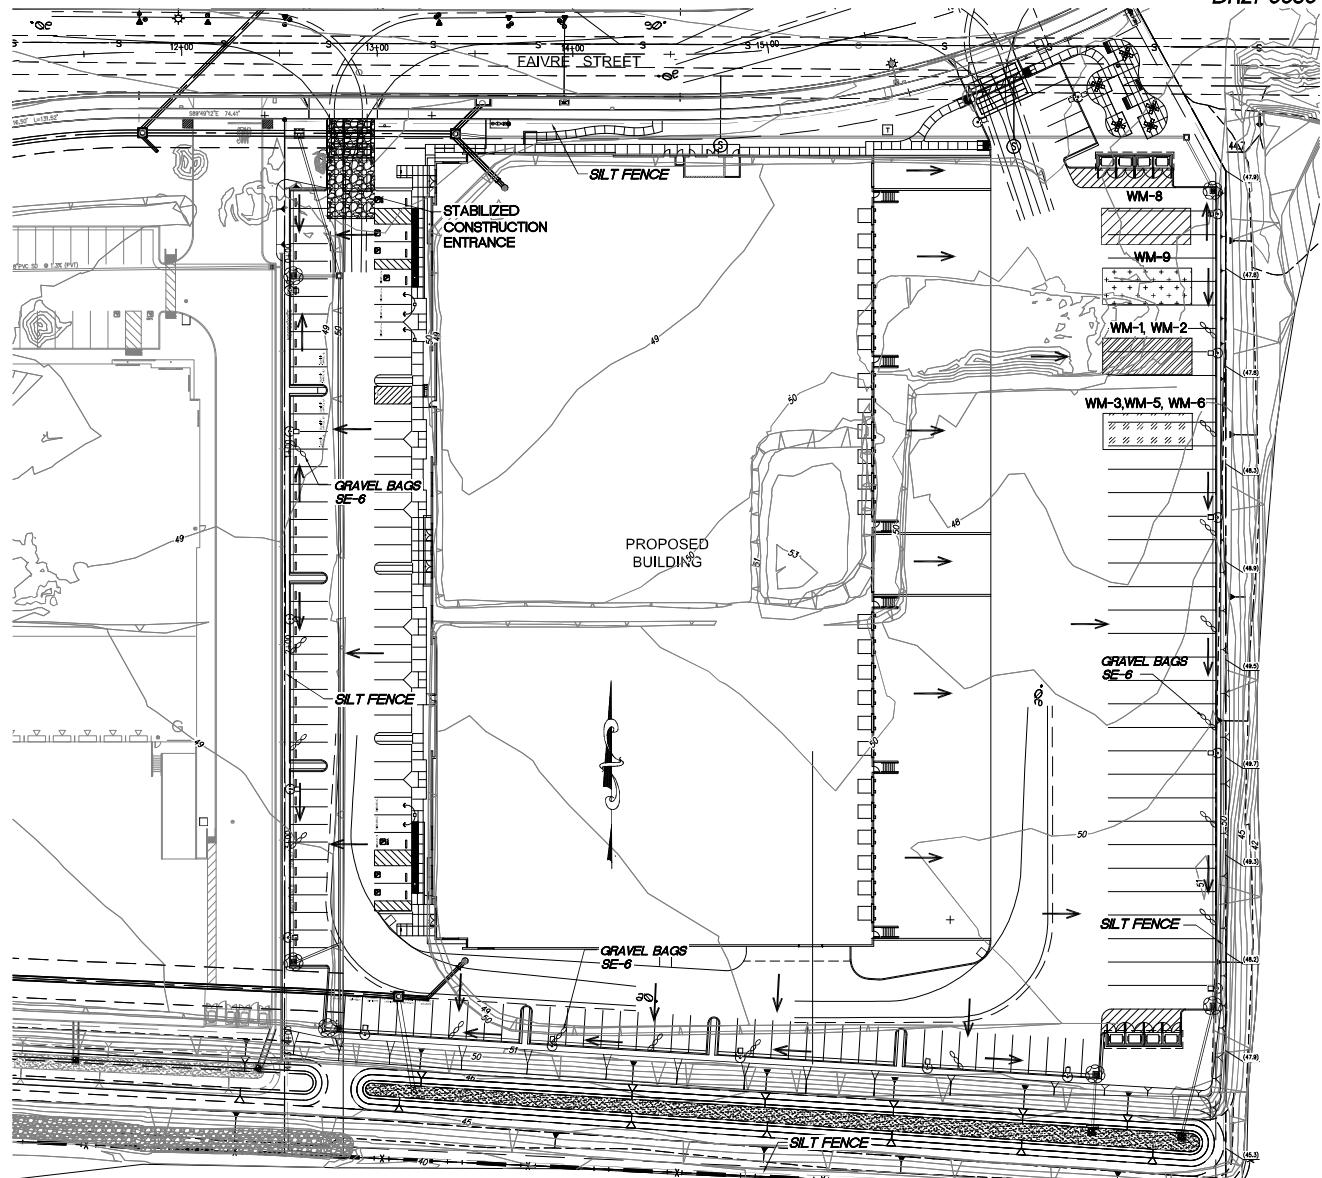

CONSTRUCTION RECORD	REFERENCES	By	REVISIONS	Date App'd
Contractor _____	_____	_____	_____	_____
Inspector _____	_____	_____	_____	_____
Date Completed _____	_____	_____	_____	_____

BENCH MARK

CITY OF CHULA VISTA BENCH MARK # 1600
E SIDE BROWNS ROAD S OF 7TH AVENUE ST.
@ THE END OF BRIDGE ON BRIDGE CURE
ELEV. + 46.310' (NAVD88)

SCALE	Designed by	Drawn by	Checked By
HORIZONTAL S.M.O.	G.M.O.	G.M.O.	K.S.S.
Vertical N/A			
VERTICAL N/A	Plans Prepared Under Supervision Of		
	Date		
	R.C.E. No.		
	48592		

CITY OF CHULA VISTA DEVELOPMENT SERVICES DEPARTMENT Drawing No. _____
GRADING AND DRAINAGE PLANS FOR: OTAY RIVER BUSINESS PARK
PARCEL 2 (LOT 12 OF CHULA VISTA TRACT NO. PCS 16-0007)
W.O. NO. _____
SHEET 4 OF 4
JN 21-039



SCA ARCHITECTURE




8841 RESEARCH DR
SANTA CRUZ
IRVINE, CA 92618
949.387.1222
[RLAELLA.COM](http://rlaella.com)

Creative Opportunities QOZB, LP

OTAY RIVER BUSINESS PARK
PARCEL 2 (LOT 12 OF CHULAVISTA TRACT NO. PCS 16-0007)

PRELIMINARY SHADE DIAGRAM

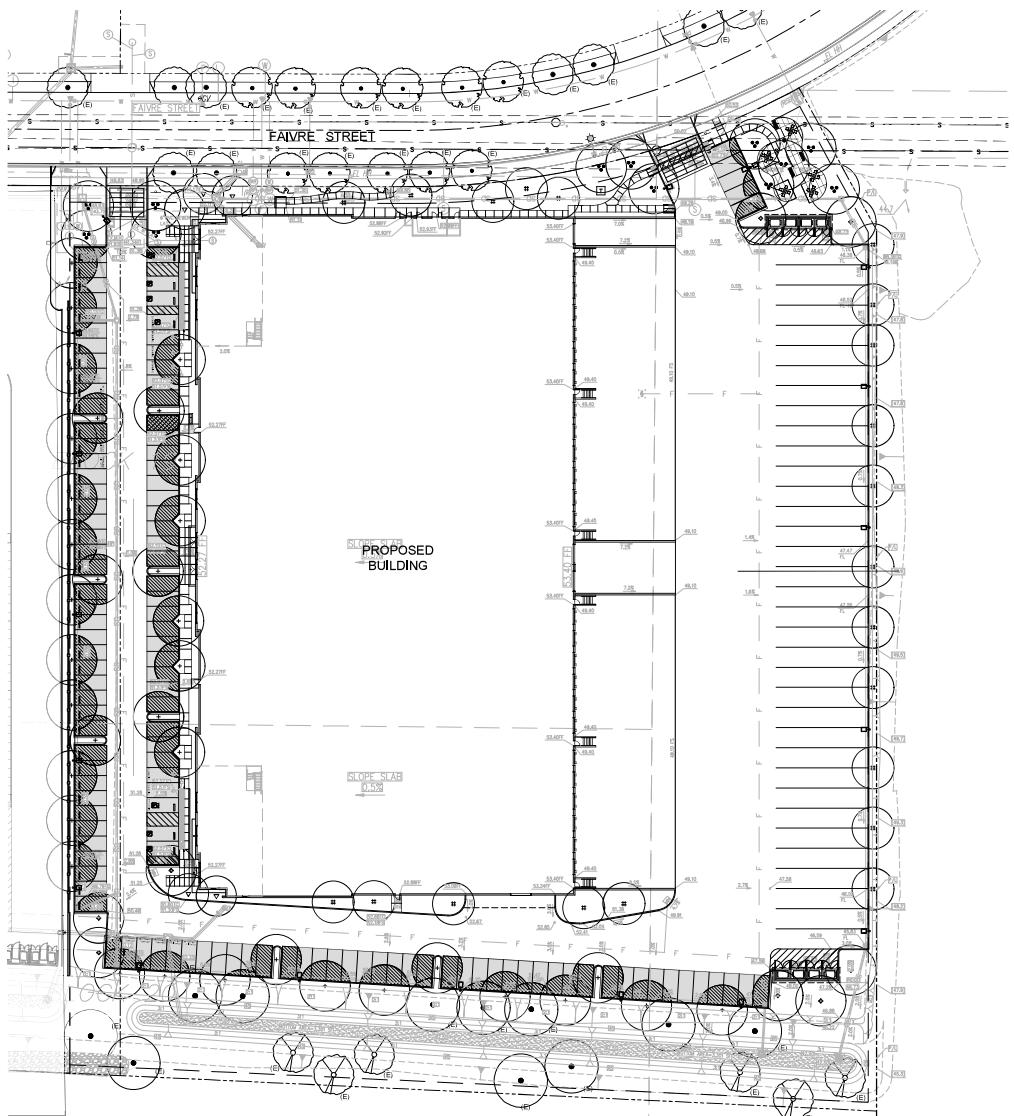

SHADE CALCULATION	
TOTAL AREA OF PARKING STALLS	= 21,764 SF.
TOTAL REQUIRED SHADE AREA (50%)	= 10,882 SF.
TOTAL AREA OF SHADE FROM TREES (TREES AT 5 YEARS Maturity)	= 11,829 SF.
TOTAL SHADe AREA	= 11,825 SF. (53.4%)

SHADE AND PAVING LEGEND

	AREA OF PARKING STALLS & ASSOCIATED VEHICULAR CIRCULATION
	SHADE PROVIDED BY TREES AT 5 YEARS GROWTH

PROPOSED PLANT PALETTE

SYMBOL	BOTANICAL NAME	COMMON NAME	SIZE
TREES			
	CERCIODIUM DESERT MUSEUM	DESERT MUSEUM PALO BERGE	24" BOX STD.
	GERGO CHANGENISIS FOREST PANSY	FOREST PANSY EASTERN REDBUD	24" BOX STD.
	LOPHOSTEMON CONFERTUS	BRISBANE BOX	15 GAL. STD.
	ULMUS PARVIFOLIA 'TRUE GREEN'	TRUE GREEN ELM	24" BOX STD.
	RHUS LANCEA	AFRICAN SUMAC	24" BOX STD.

PROPOSED TREES FOR OTAY RIVER BUSINESS PARK, DWG. NO. 18037

SYMBOL	BOTANICAL / COMMON NAME
	JACARANDA MIMOSIFOLIA / JACARANDA
	PLATANUS RACEMOSA / CALIFORNIA Sycamore
	QUERCUS AGRIFOLIA / COAST LIVE OAK
	ULMUS PARVIFOLIA 'TRUE GREEN' / TRUE GREEN ELM

NOTE: PARKWAY PLANTING AND SLOPE PLANTING PER SEPARATE PERMIT.

DR PROJECT # DR210036

Revision Dates

A			
B			
C			
D			
E			

Issue Dates

1st Design Review 12/01/2021

2nd Design Review 04/20/2022

3rd Design Review 06/06/2022

Bid Set -

Permit Set -

Construction Set -

Drawing Date 04/20/2022


Check By RLA

Drawn By RLA

Scale AS NOTED


Job Number 11009.S1201

Sheet Number

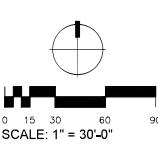

SCALE: 1" = 30'-0"

L2.1

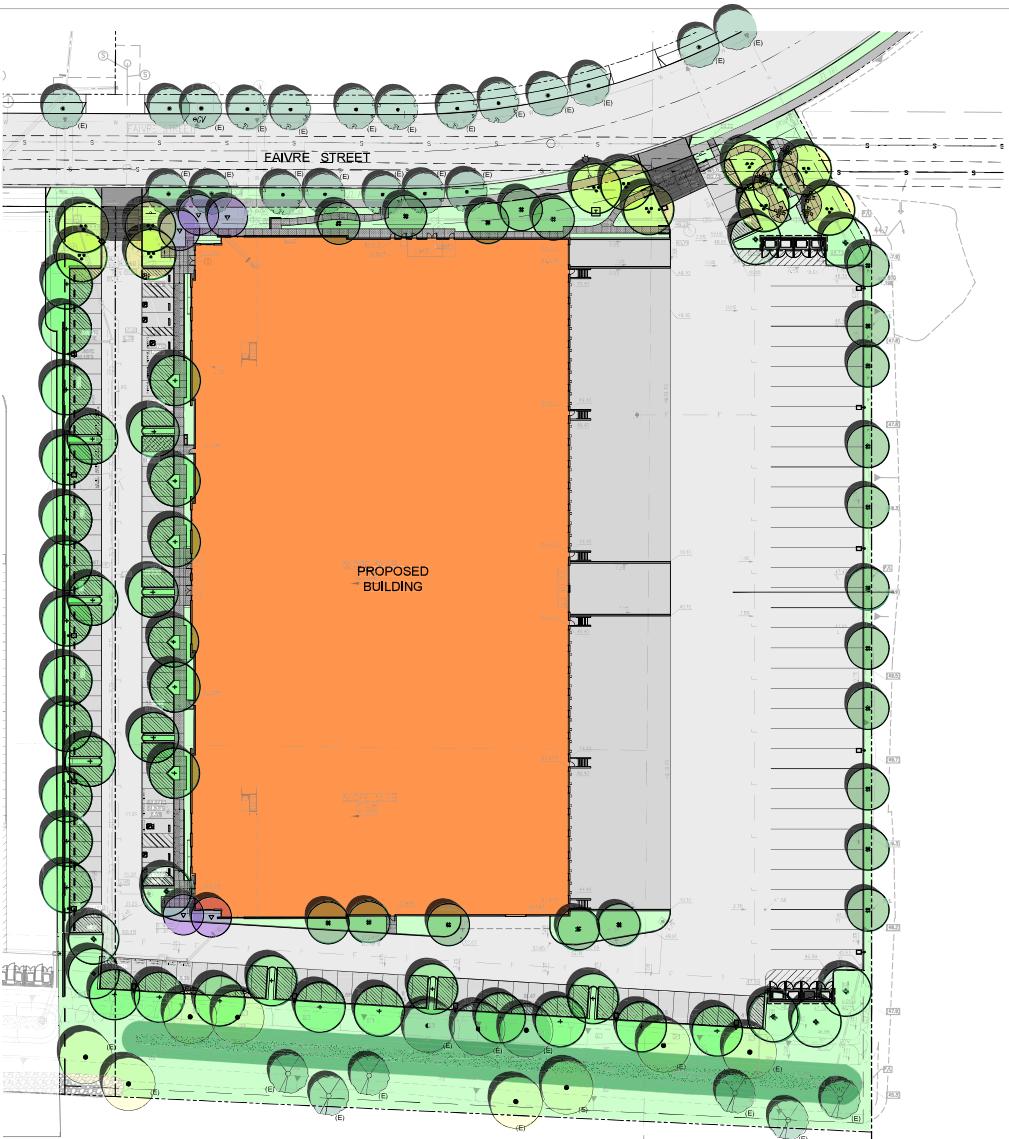

SHADE CALCULATION

TOTAL AREA OF PARKING STALLS	= 21,764 SF.
TOTAL REQUIRED SHADE AREA (50%)	= 10,882 SF.
TOTAL AREA OF SHADE FROM TREES (TREES AT 5 YEARS Maturity)	= 11,829 SF.
TOTAL SHADe AREA	= 11,825 SF. (53.4%)

SHADE AND PAVING LEGEND

	AREA OF PARKING STALLS & ASSOCIATED VEHICULAR CIRCULATION
	SHADE PROVIDED BY TREES AT 5 YEARS GROWTH

PROPOSED PLANT PALETTE

SYMBOL	BOTANICAL NAME	COMMON NAME	SIZE
TREES			
	CERIDIUM DESERTUM	DESERT MUSEUM / PALO BERGE	24" BOX STD.
	GERIGO CHANGENSIS	FOREST PANSY / EASTERN REDBUD	24" BOX STD.
	LOPHOSTEMON CONFERTUS	BRISBANE BOX	15 GAL. STD.
	ULMUS PARVIFOLIA	TRUE GREEN ELM	24" BOX STD.
	RHUS LANCEA	AFRICAN SUMAC	24" BOX STD.

PROPOSED TREES FOR OTAY RIVER BUSINESS PARK, DWG. NO. 18037

SYMBOL	BOTANICAL / COMMON NAME
	JACARANDA MIMOSIFOLIA / JACARANDA
	PLATANUS RACEMOSA / CALIFORNIA Sycamore
	QUERCUS AGRIFOLIA / COAST LIVE OAK
	ULMUS PARVIFOLIA 'TRUE GREEN' / TRUE GREEN ELM

NOTE: PARKWAY PLANTING AND SLOPE PLANTING PER SEPARATE PERMIT.


DR PROJECT # DR210036

Revision Dates

A	
B	
C	
D	
E	


Issue Dates

1st Design Review	12/01/2021
2nd Design Review	04/27/2022
3rd Design Review	05/10/2022
Bid Set	-
Permit Set	-
Construction Set	-
Drawing Date	04/20/2022
Check By	RLA
Drawn By	RLA
Scale	AS NOTED
Job Number	11009.S1201
Sheet Number	L2.1

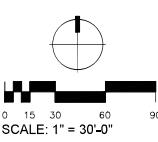


L2.1

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Fixture List

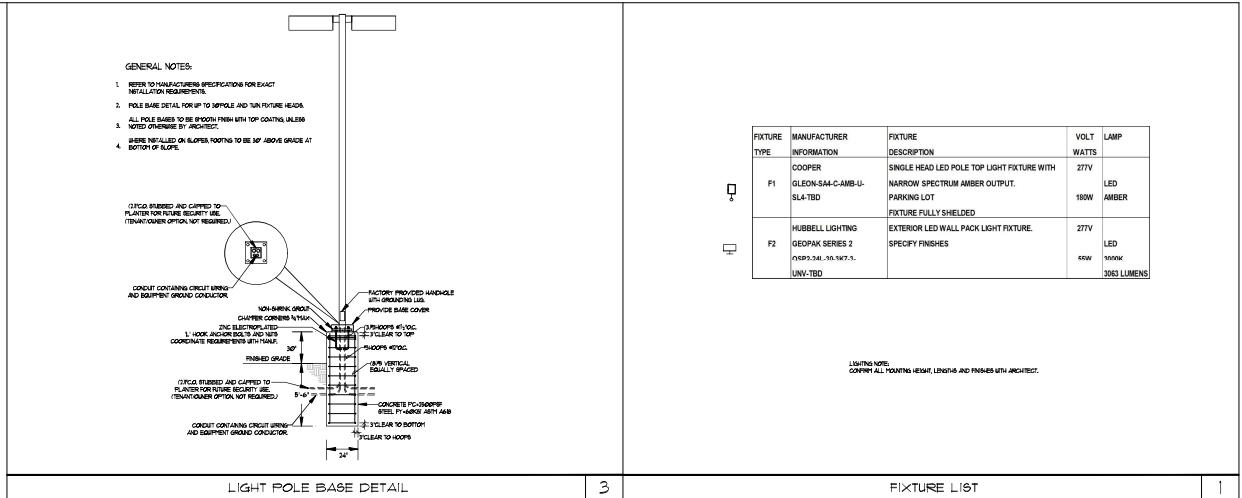

West Exterior Elevation

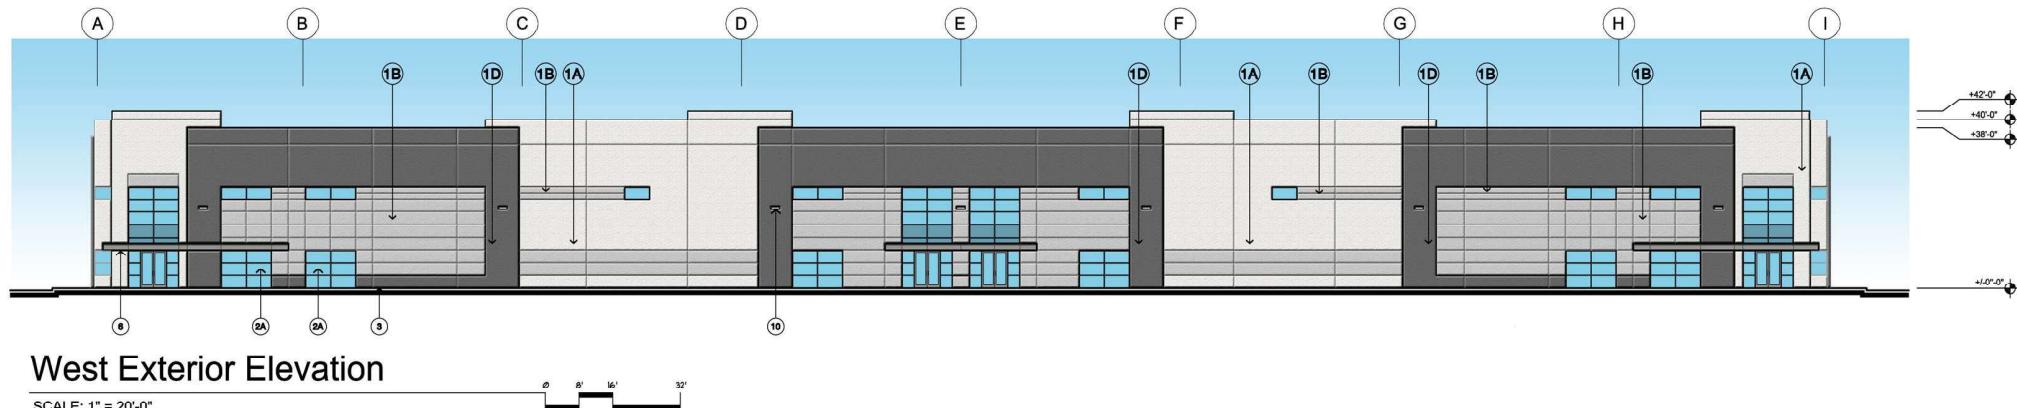SCALE: 1" = 20'-0"

0' 8' 16' 32'




①A PAINTED CONCRETE WALL
SNOWFALL SW 6000



①B PAINTED CONCRETE WALL
CHELSEA GREY SW 2850



①C PAINTED CONCRETE WALL
TIN LIZZIE SW 9163

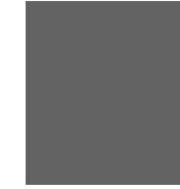

①D PAINTED CONCRETE WALL
GRIZZEL GRAY SW 7068



②A VISION GLASS
PPC SOLABAN 60
SOLARBLUE



②B SPANDREL GLASS
PPC OPACI-COAT-300
#6 1919 WESTERN WIND



⑥ METAL AWNING
ALPOLIC METAL PANELS
CVG GREY



ALUMINUM STOREFRONT
ARCADIA #11/CLEAR AC-2



⑩ EXTERIOR WALL MOUNTED LIGHT FIXTURE
HUBLEE GEOPAK SERIES 2
BUILDING WALL LIGHT